


SITE PLAN GENERAL NOTES (SHEET A1.0)

- PROPOSED BUILDING ELEVATION SHOWN AS: MAIN FLOOR FINISHED FLOOR EL. = 100'-0"
- ALL GROUND SHALL PITCH AWAY FROM BUILDING AT A MINIMUM OF 4% +/- UNLESS NOTED OTHERWISE. MAINTAIN POSITIVE DRAINAGE AWAY FROM BUILDING.
- CONCRETE SURFACES SHALL SLOPE @ 1/8" = 1'-0" MINIMUM AWAY FROM BUILDING UNLESS SPECIFICALLY NOTED OTHERWISE.

Legend


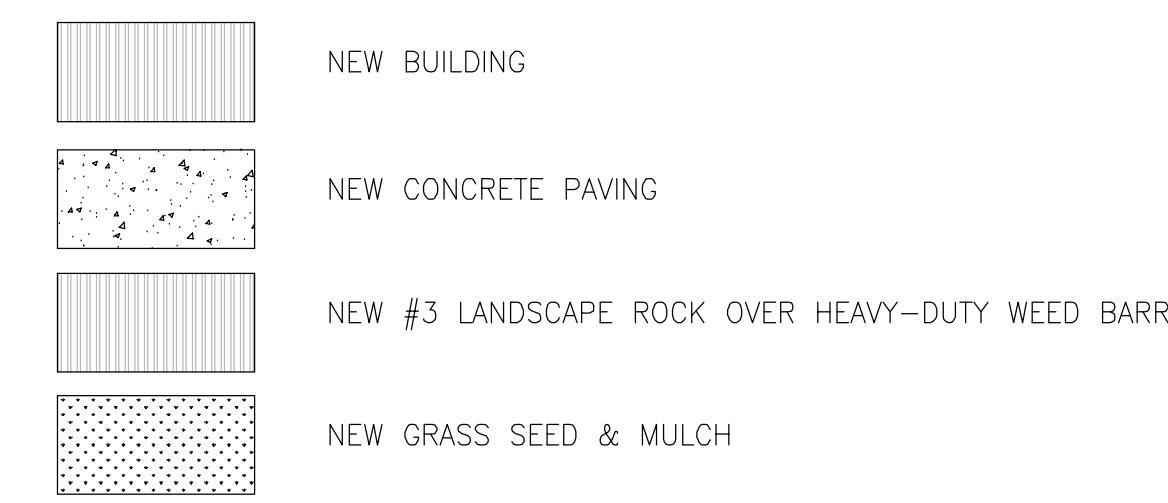


Site Layout Plan


1" = 16'-0"

KEYED NOTES (CONT'D) (SHEET A1.0)

- NEW CONCRETE PAVING (4000 PSI), WIDTH AS SHOWN. 6" THICK W/ FIBERMESH & #4 REBAR REINFORCING @ 18" C/C BOTH WAYS OVER 12" COMPACTED CRUSHED LIMESTONE. TOP OF FINISHED SURFACE FLUSH W/ FINISHED FLOOR AND / OR ADJACENT SOIL. INSTALL CONTROL JOINTS PER STANDARD PRACTICE. BROOM & TOOL FINISH. DOWELL ATTACH PAVING INTO ADJACENT BUILDING FOUNDATION- 18" LENGTH #5 DOWELLS @ 24" C/C. SLOPE SURFACE AT 1/8" PER FT. AWAY FROM BUILDING MINIMUM
- CONCRETE STOOP, POUR FLUSH W/ INTERIOR FINISHED FLOOR HEIGHT / FLUSH WITH PAVING. SLOPE AT 1/8" PER FT. AWAY FROM BUILDING. SEE ALSO STRUCTURAL PLANS & DETAILS. 6" THICK W/ FIBERMESH TO MATCH ADJACENT DRIVEWAY
- NEW CONCRETE PAVING (4000 PSI), WIDTH AS SHOWN. 4" THICK W/ FIBERMESH & WELDED WIRE MESH OVER 8" COMPACTED CRUSHED LIMESTONE. TOP OF FINISHED SURFACE FLUSH W/ FINISHED FLOOR AND / OR ADJACENT SOIL. INSTALL CONTROL JOINTS PER STANDARD PRACTICE. BROOM & TOOL FINISH. DOWELL ATTACH PAVING INTO ADJACENT BUILDING FOUNDATION- 18" LENGTH #5 DOWELLS @ 24" C/C. SLOPE SURFACE AT 1/8" PER FT. AWAY FROM BUILDING MINIMUM
- CONCRETE STOOP, POUR FLUSH W/ INTERIOR FINISHED FLOOR HEIGHT / FLUSH WITH PAVING. SLOPE AT 1/8" PER FT. AWAY FROM BUILDING. SEE ALSO STRUCTURAL PLANS & DETAILS. 4" THICK W/ FIBERMESH TO MATCH ADJACENT SIDEWALK
- 8" SCHEDULE 80 STEEL PIPE BOLLARD. SEE DETAIL 2 / A1.0
- DOWNSPOUT ONTO 12" x 24" PRECAST CONCRETE SPLASH BLOCK
- NOT USED
- NO. 2 WASHED STONE OVER HEAVY-DUTY FABRIC WEED BARRIER.
- ADD ALTERNATE #1: 6'-0" HEIGHT WHITE VINYL FENCING

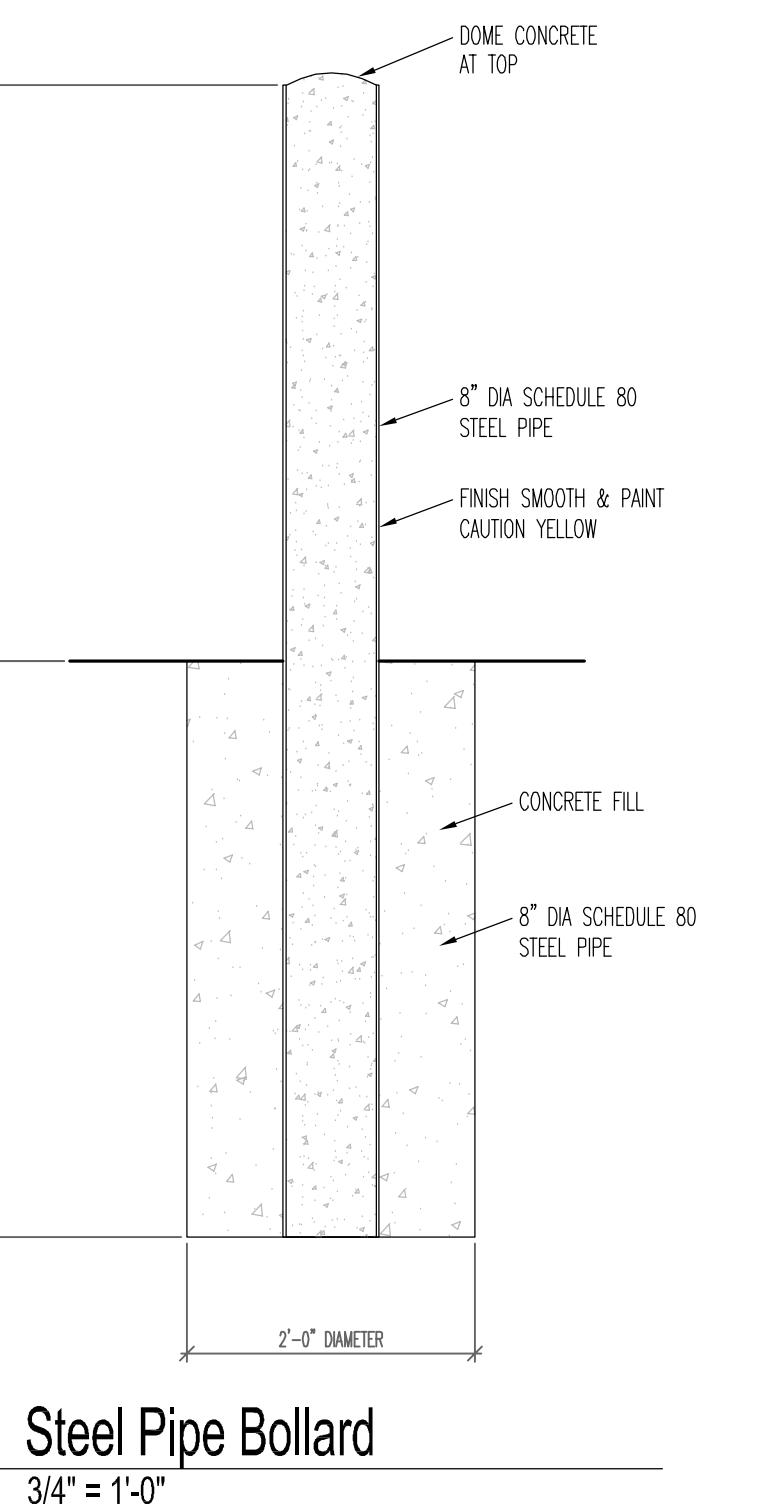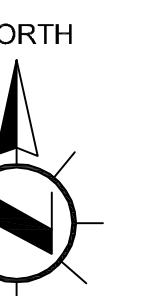

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SHEET NUMBER:		REVISIONS:		PROJECT:		Norwalk Area Fire District	
				LOCATION:	212 Main Street	Norwalk, WI	Monroe County
				PROJECT OWNER:	Norwalk Area Fire District	212 Main Street	Norwalk, WI 54648
				DATE:	November 19, 2025		

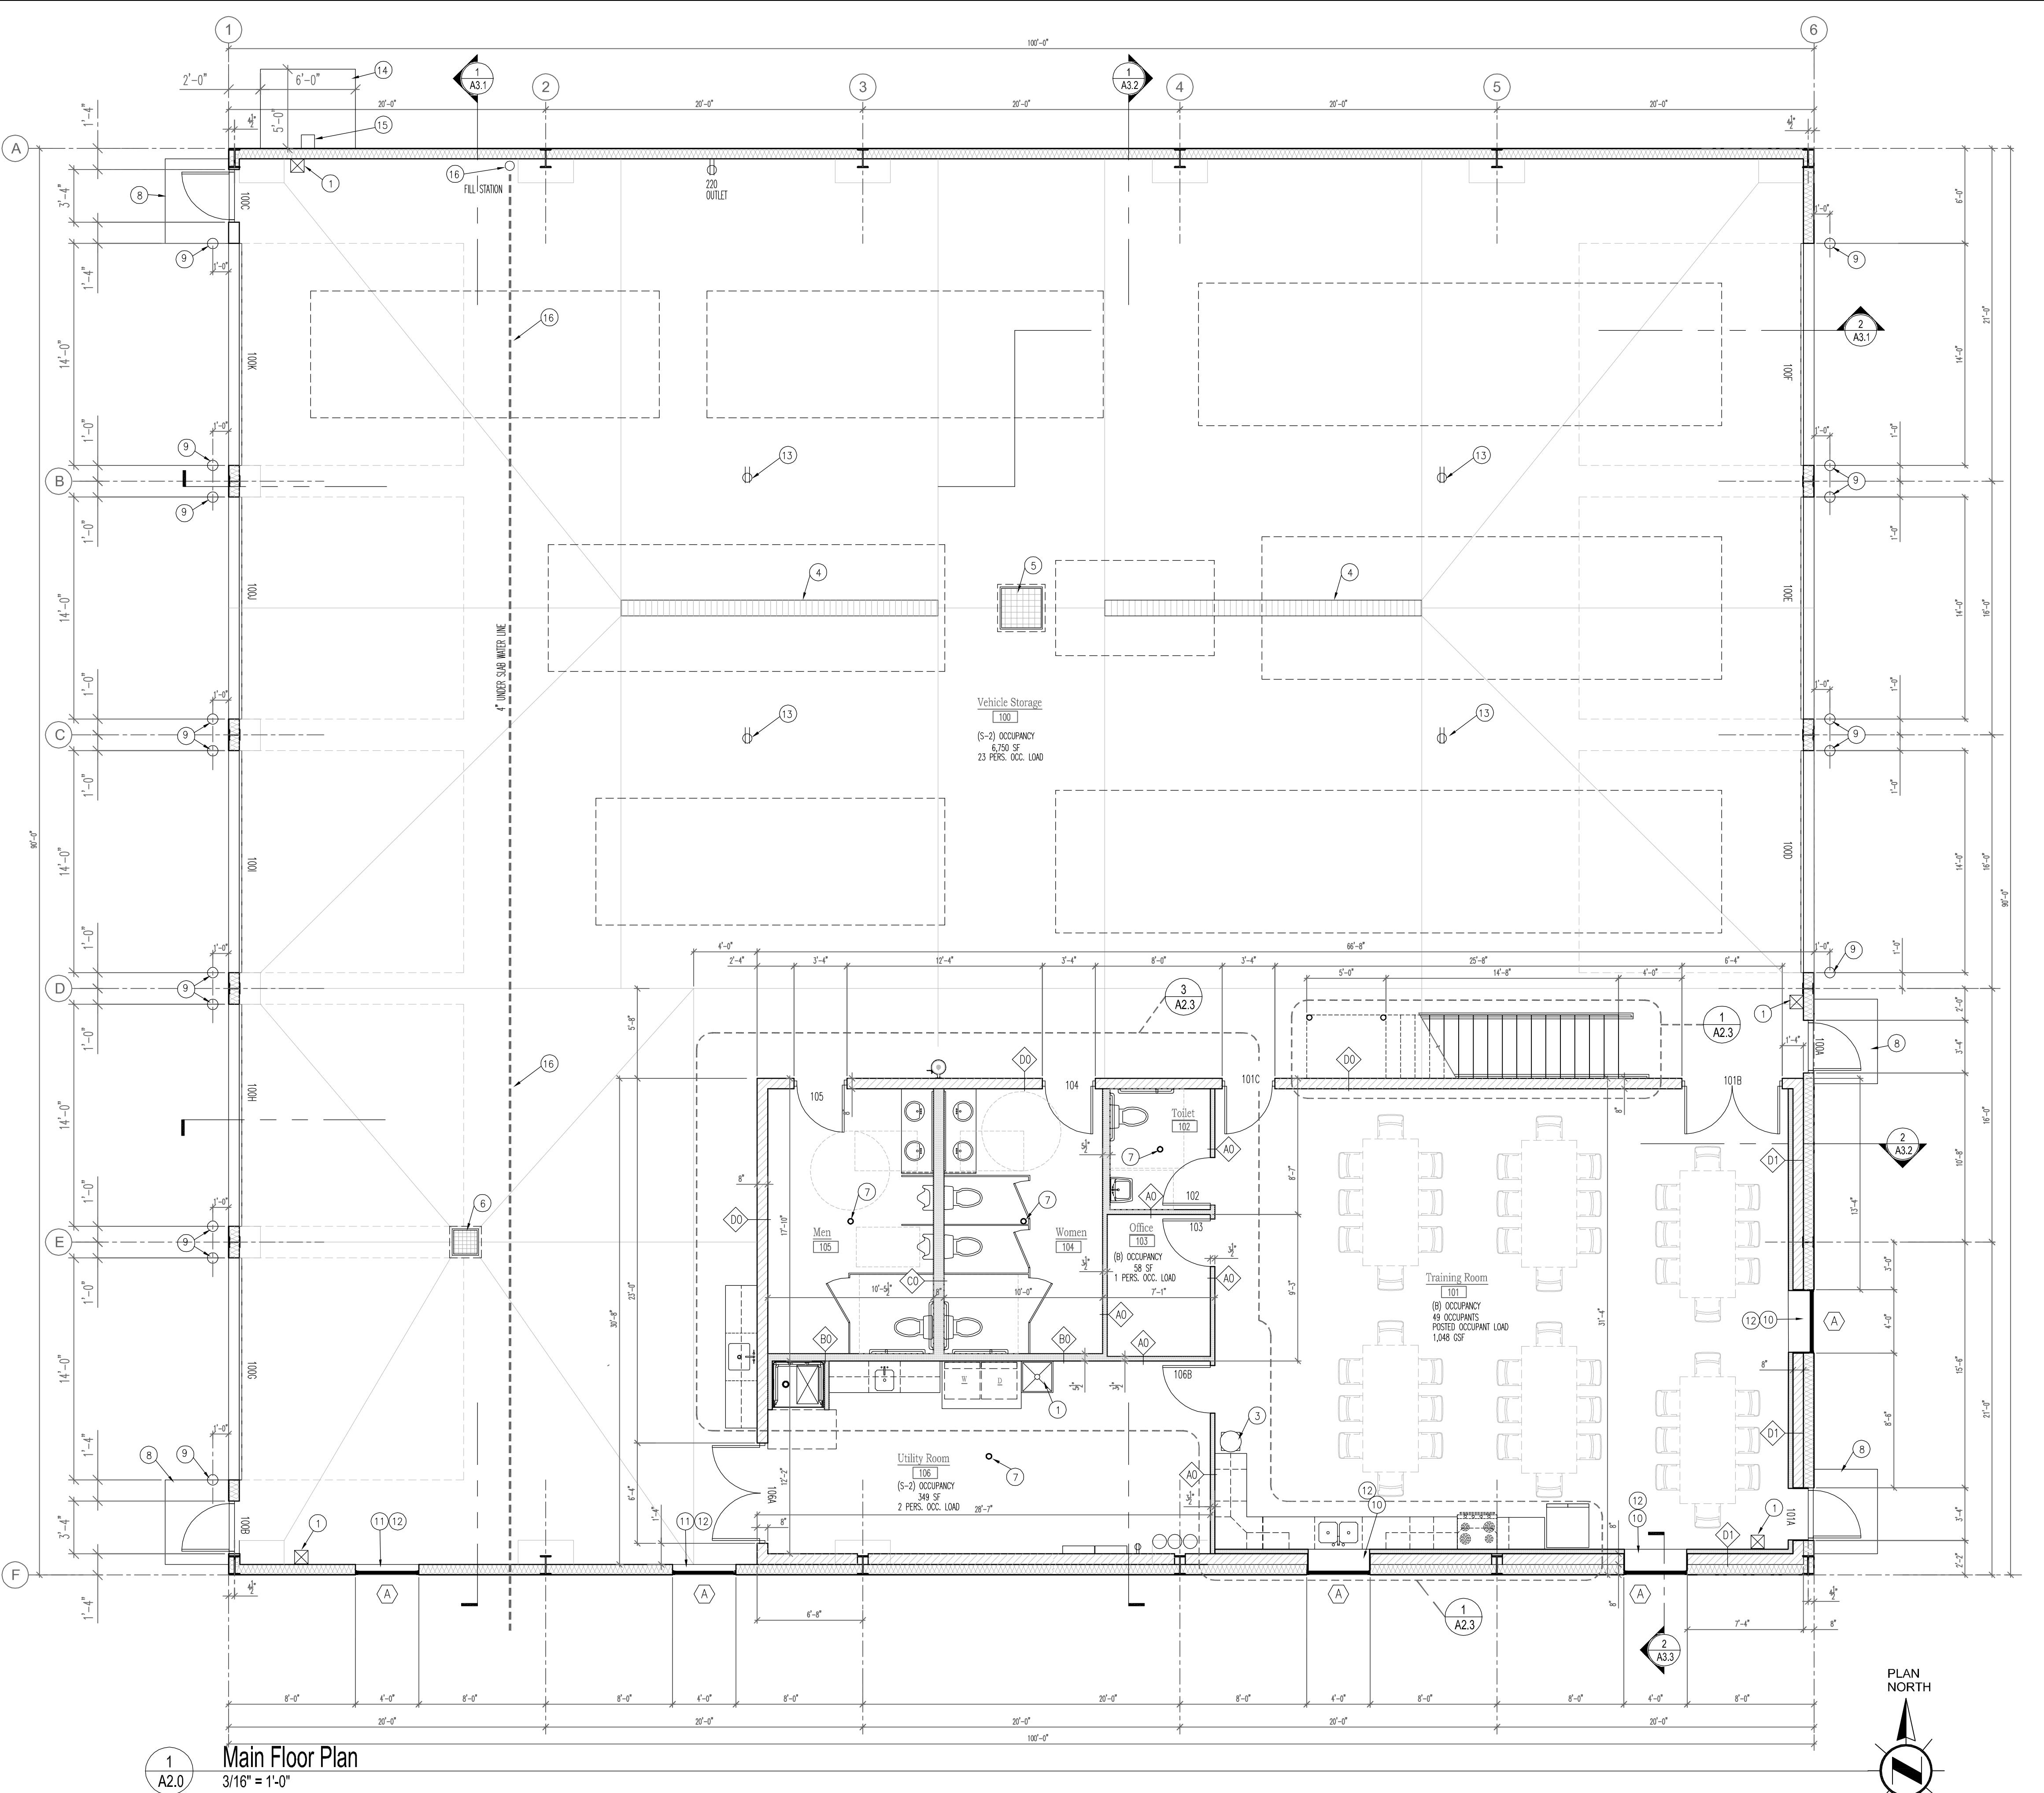

GENERAL NOTES

CONTRACTOR TO FIELD VERIFY ALL DIMENSIONS. NOTIFY ARCHITECT OF ALL SIGNIFICANT DISCREPANCIES

DIMENSIONS TYPICAL: DIMENSION LINES ARE LOCATED FROM FACE-OF-STUD -OR- TO FACE-OF-MASONRY- TYPICAL.

REFER TO STRUCTURAL DRAWINGS FOR LOCATIONS OF ALL FOOTINGS, FOUNDATION WALLS, BEAMS, AND HEADERS.

PROPOSED AND EXISTING ELEVATIONS ARE SHOWN AS:

MAIN LEVEL F.F.E.
EL.= 100'-0"

CONSTRUCTION SHALL BE IN ACCORDANCE WITH STATE AND LOCAL CODES.

ALL DOORS TO BE EQUIPPED WITH ADA-LEVERSET HARDWARE

ALL EXTERIOR DOOR THRESHOLDS SHALL BE NO MORE THAN 1/2" IN HEIGHT.

VERIFY ALL EXISTING CONDITIONS, DIMENSIONS, AND ALIGNMENT OF WALLS. BRING ANY DISCREPANCIES TO THE ARCHITECTS ATTENTION PRIOR TO START OF FABRICATION/CONSTRUCTION.

PROVIDE 5/8" GYPSUM BOARD AT ALL LOCATIONS UNLESS OTHERWISE NOTED. PROVIDE 5/8" MOISTURE RESISTANT GYPSUM BOARD AT PLUMBING PARTITIONS AND PARTITION FACE WITHIN 6'- 0" OF ALL PLUMBING FIXTURES. PROVIDE CEMENT PLASTER BOARD AS BACK-UP AT ALL CERAMIC WALL TILE LOCATIONS.

OLD 5/8" CLEARANCE BETWEEN FLOOR AND GYPSUM BOARD. FILL GAP BETWEEN BOTTOM EDGE OF GYPSUM BOARD AND FLOOR WITH MOISTURE RESISTANT MASTIC CAULKING. STRIKE COMPOUND SMOOTH AND FLUSH WITH FACE OF PARTITION. REMOVE EXCESS MASTIC CAULKING FROM PARTITION AND FLOOR.

ALL VINYL OR FABRIC WALL COVERING AT CORRIDOR CORNER LOCATIONS TO RECEIVE A CLEAR PLASTIC CORNER GUARD TO A HEIGHT OF 8' - 0" A.F.F. (IPC INSTITUTIONAL PRODUCTS CORP #8118 OR APPROVED EQUAL) UNLESS OTHER PROTECTION IS SPECIFIED.

CHANGES IN FLOOR MATERIALS SHALL BE LOCATED AT THE CENTERLINE OF DOORS UNLESS NOTED OTHERWISE.

VERIFY LOCATION OF ACCESS PANELS WITH MECHANICAL AND ELECTRICAL DRAWINGS FOR ACCESS TO MECHANICAL AND ELECTRICAL ITEMS.

ALL PENETRATIONS IN FIRE RATED ASSEMBLIES AND SMOKE CARRIERS TO MEET REQUIRED RATINGS. UTILIZE UL APPROVED METHODS.

URING CONSTRUCTION, AREA SHALL BE KEPT BROOM CLEAN AND FREE OF DEBRIS.

ALL PENETRATIONS OF EXTERIOR WALL ARE TO BE MADE AIR TIGHT.

ALL PENETRATIONS OF FIRE-RATED WALLS TO BE FIRE-STOPPED WITH CODE COMPLIANT / U.L. LISTED FIRE CAULK AND/OR FIRESTOPPING.

ALL PENETRATIONS OF EXTERIOR WALL ARE TO BE MADE AIR TIGHT.

PUBLIC RESTROOMS SHALL BE COVERED WITH SMOOTH, HARD, NONABSORBENT MATERIALS EXTENDING A MINIMUM OF 6" ABOVE FLOOR LEVEL. WALLS WITHIN 2 FT. OF URINALS OR WATER CLOSETS SHALL BE COVERED A MINIMUM OF 4 FT. ABOVE FLOOR LEVEL.

DOM(S) WITH A MOP BASIN OR UTILITY SINK SHALL HAVE AN EXHAUST FAN WHICH RUNS CONTINUOUSLY WHILE THE BUILDING IS OCCUPIED.

ALL EXTERIOR DOOR THRESHOLDS SHALL BE NO MORE THAN 1/2" IN HEIGHT.

CHANGES IN FLOOR MATERIALS SHALL BE LOCATED AT THE CENTERLINE OF DOORS UNLESS NOTED OTHERWISE.

ALL PENETRATIONS IN FIRE RATED ASSEMBLIES AND SMOKE CARRIERS TO MEET REQUIRED RATINGS. UTILIZE UL APPROVED METHODS.

REFERENCE NOTES

SEE DETAIL 2 / A2.1 FOR PARTITION TYPES
SEE A2.1 FOR DOOR & FINISH SCHEDULES
REFER TO STANDARD MOUNTING HEIGHTS, DET 3 / A2.2
OR ADA MOUNTING HEIGHT DETAILS.
REFER TO ELEVATIONS & DETAIL 5 / A3.0 FOR

DIMENSION NOTES

EXTERIOR WALLS DIMENSIONED TO FACE OF STUD AND/OR FACE OF MASONRY

KEYED NOTES

FIRE EXTINGUISHER CABINET, SURFACE-MOUNTED
FIRE EXTINGUISHER: ORDINARY HAZARD- 2-A-B-C RATED
WALL MOUNTING: TOP-OF-EXTINGUISHER
@ 42" ABOVE FINISHED FLOOR

24 x 24 FLOOR-MOUNTED SERVICE SINK

WATER COOLER WATER DRINKING FACILITY

CONTINUOUS TRENCH DRAIN

36" x 36"x 36" PRECAST CATCH BASIN WITH HEAVY-DUTY STEEL GRATE

24" x 24"x 24" PRECAST CATCH BASIN WITH HEAVY-DUTY STEEL GRATE

FLOOR DRAIN

CONCRETE STOOP. SEE STRUCTURAL

8" DIA SCHEDULE 80 STEEL PIPE BOLLARD, CONCRETE FILLED TO DOME TOP.
PAINT CAUTION YELLOW. SEE DETAIL 2 / A1.0

PAINTED 5/8" GYP BOARD HEAD & JAMBS

PAINTED BRAKE METAL HEAD & JAMBS

1/2" THICKNESS CULTURED MARBLE SILL

20 AMP, CEILING-MOUNT OUTLET ON RETRACTABLE CORD REEL

4" THICK CONCRETE SLAB FOR EMERGENCY GENERATOR

EMERGENCY GENERATOR ELECTRICAL BACKFEED BOX.
CONNECT BACK TO MAIN PANEL. PROVIDE CODE-COMPLIANT
SWITCH CONNECTION.


PROVIDE 4" WATER LINE FROM MUNICIPAL SUPPLY TO LOCATION
SHOWN FOR WATER TANKER TRUCK RECHARGE STATION

DOOR/ FRAME SCHEDULE										
DOOR NO.	DOOR				FRAME			TYPE: 1 SEE NOTES- BELOW	HARDWARE GROUP A2.1	REMARKS
	SIZE	THICKNESS	MATERIAL	FINISH	U-CUT OR LOUVER	MATERIAL	FINISH			
MAIN FLOOR										
100A	3'-0" x 7'-0"	1-3/4"	STEEL	PAINT	B	-	STEEL	PAINT	B	E-1
100B	3'-0" x 7'-0"	1-3/4"	STEEL	PAINT	B	-	STEEL	PAINT	B	E-1
100C	3'-0" x 7'-0"	1-3/4"	STEEL	PAINT	B	-	STEEL	PAINT	B	E-1
100D	14' x 14'h				D					INSULATED SECTIONAL OVERHEAD DOOR
100E	14'w x 14'h				D					INSULATED SECTIONAL OVERHEAD DOOR
100F	14'w x 14'h				D					INSULATED SECTIONAL OVERHEAD DOOR
100G	14'w x 14'h				D					INSULATED SECTIONAL OVERHEAD DOOR
100H	14'w x 14'h				D					INSULATED SECTIONAL OVERHEAD DOOR
100I	14'w x 14'h				D					INSULATED SECTIONAL OVERHEAD DOOR
100J	14'w x 14'h				D					INSULATED SECTIONAL OVERHEAD DOOR
100K	14'w x 14'h				D					INSULATED SECTIONAL OVERHEAD DOOR
101A	3'-0" x 7'-0"	1-3/4"	SC-WOOD	STAIN	B	-	STEEL	PAINT	B	E-1
101B	PAIR 3'-0" x 7'-0"	1-3/4"	SC-WOOD	STAIN	C	-	STEEL	PAINT	C	C-1
101C	3'-0" x 7'-0"	1-3/4"	SC-WOOD	STAIN	B	-	STEEL	PAINT	C	C-2
102	3'-0" x 7'-0"	1-3/4"	SC-WOOD	STAIN	A	-	STEEL	PAINT	A	T-1
103	3'-0" x 7'-0"	1-3/4"	SC-WOOD	STAIN	B	-	STEEL	PAINT	B	O-1
104	3'-0" x 7'-0"	1-3/4"	SC-WOOD	STAIN	A	-	STEEL	PAINT	A	P-1
105	3'-0" x 7'-0"	1-3/4"	SC-WOOD	STAIN	A	-	STEEL	PAINT	A	P-1
106A	PAIR 3'-0" x 7'-0"	1-3/4"	SC-WOOD	STAIN	C	-	STEEL	PAINT	C	C-1
106B	3'-0" x 7'-0"	1-3/4"	SC-WOOD	STAIN	B	-	STEEL	PAINT	A	C-2

HARDWARE GROUPS (AS NOTED ON DOOR/ HARDWARE SCHEDULE)

ALL HARDWARE TO BE ANSI GRADE 1 STANDARD


E-1 ALUMINUM EXTERIOR DOOR	P-1 PASSAGE	T-1 TOILET	O-1 OFFICE	C-1 CLASSROOM	C-2 CLASSROOM
ADA - ENTRANCE LEVERSET-EXTERIOR-KEYPAD COMBINATION RIM PANIC EXIT DEVICE- INTERIOR BUTTS (3) CLOSER 34" x 34" ARMOR PLATE H/C-ACCESS THRESHOLD WEATHER SEAL/ SWEEP KICK-DOWN DOOR HOLD-OPEN	PUSH PLATE- PUSH SIDE PULL HANDLE- PULL SIDE BUTTS (3) CLOSER KICK-DOWN DOOR HOLD-OPEN 10" x 34" KICK PLATE-PUSH SIDE	ADA-PRIVACY LEVERSET BUTTS (3) WALL BUMPER DOOR BOTTOM SEAL 10" x 34" KICK PLATE	ADA-OFFICE LEVERSET BUTTS (3) WALL BUMPER DOOR BOTTOM SEAL 10" x 34" KICK PLATE	ADA-CLASSROOM LEVERSET BUTTS (3) CLOSER KICK-DOWN DOOR HOLD-OPEN 34" x 34" ARMOR PLATE SECONDARY LEAF: ADA-DUMMY LEVERSET BUTTS (3) 1" FLUSH DOOR SECURITY BOLT CLOSER KICK-DOWN DOOR HOLD-OPEN 34" x 34" ARMOR PLATE	ADA-CLASSROOM LEVERSET BUTTS (3) CLOSER KICK-DOWN DOOR HOLD-OPEN 34" x 34" ARMOR PLATE

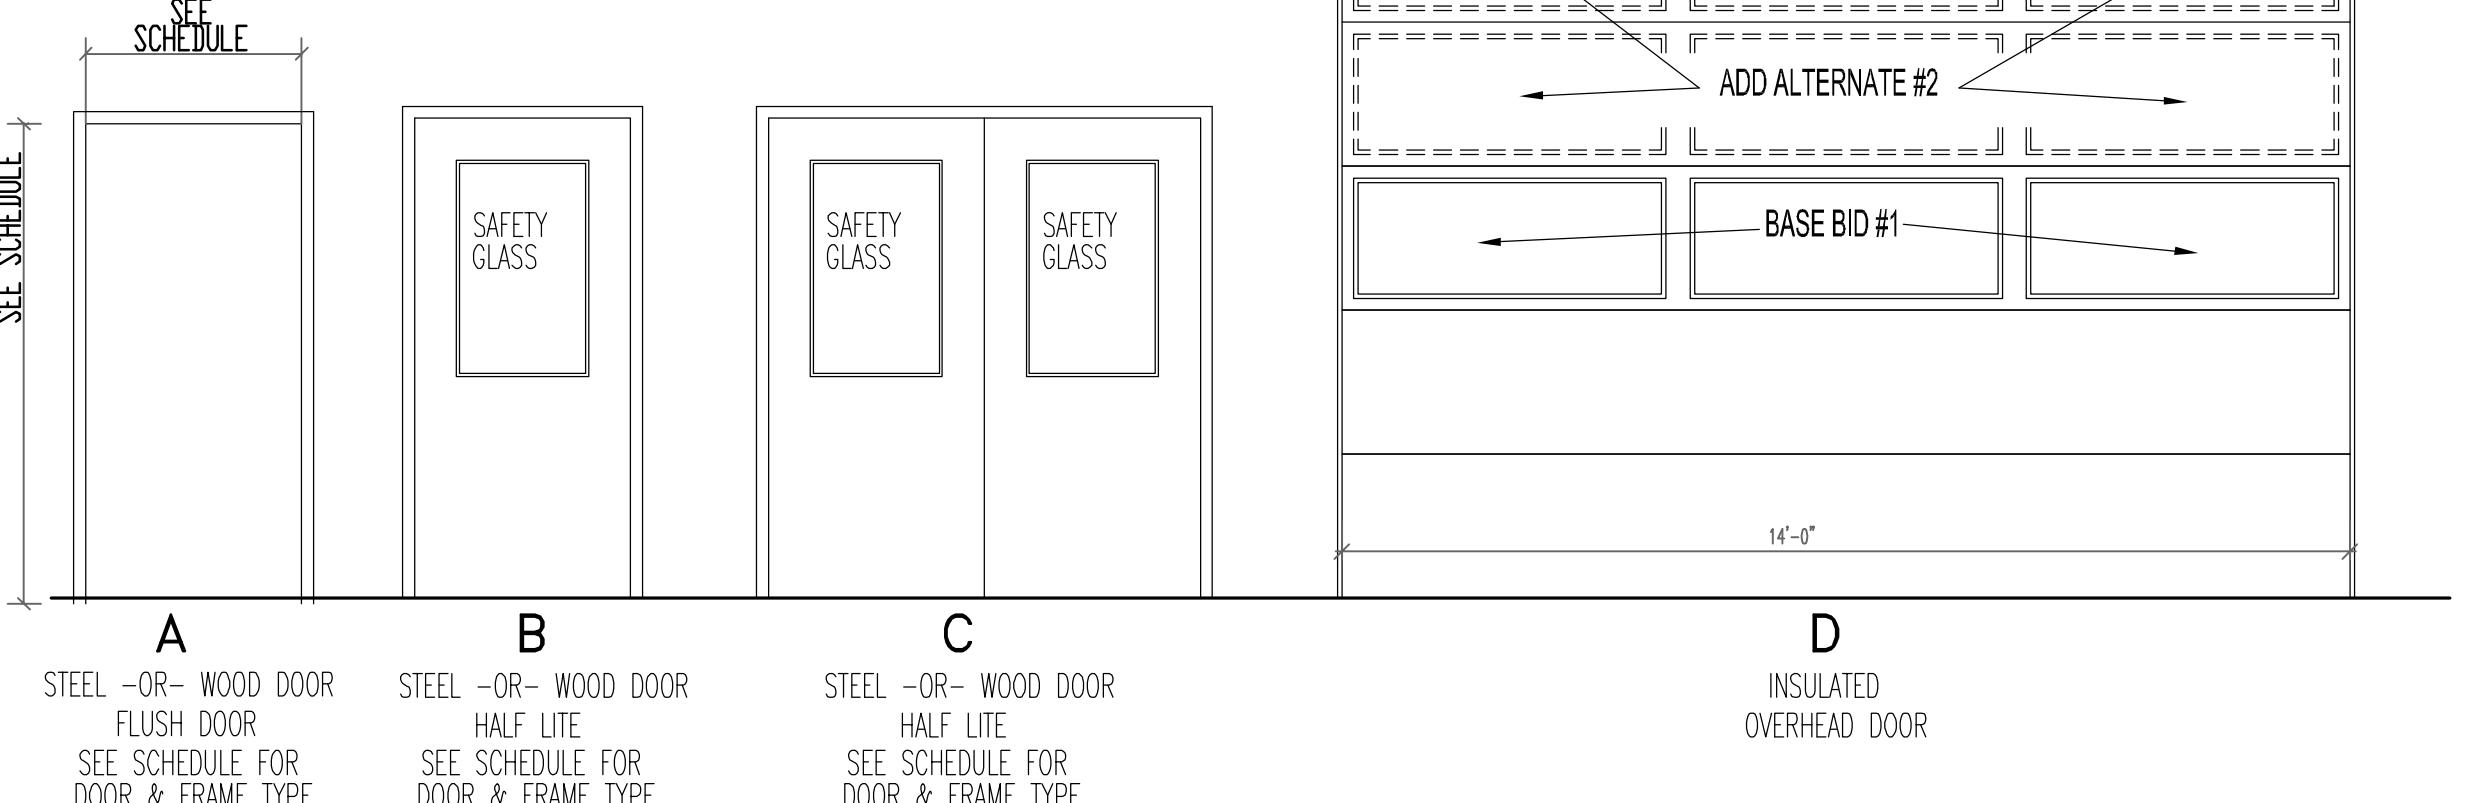

DOOR/ FRAME TYPES

3/8" = 1'-0"

A2.1

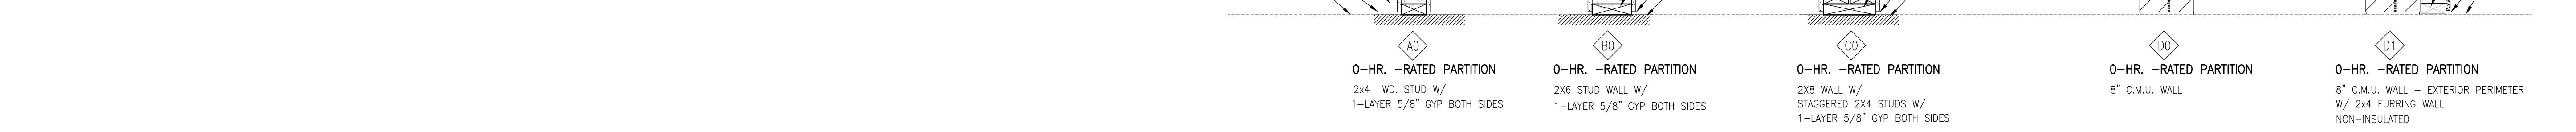

2
A2.1
Partition Types
1" = 1'-0"

ROOM FINISH SCHEDULE										
NO.	NAME	FLOOR	WALLS				CEILING	REMARKS		
			MATERIAL	BASE	NORTH	EAST	SOUTH	WEST		
100	Vehicle Storage	S.CONC.	--	①	②	① ③	②	MTL BLDG.	VAULTED	CEILING HEIGHT VARIES- SEE PLAN & SECTIONS
101	Training Room	S.CONC.	VB-4"	C.M.U./PAINT	GYP./PAINT	M.R. GYP. / PAINT	GYP./PAINT	PCAST/PAINT	8'-8"	METAL BUILDING LINER PANEL ABOVE PLYWOOD
102	Toilet	S.CONC.	VB-4"	C.M.U./PAINT	M.R. GYP. / PAINT	M.R. GYP. / PAINT/ PCT ④	M.R. GYP. / PAINT/ PCT ④	PCAST/PAINT	8'-8"	METAL BUILDING LINER PANEL- ENTIRE WALL
103	Office	S.CONC.	VB-4"	GYP./PAINT	GYP./PAINT	GYP./PAINT	GYP./PAINT	PCAST/PAINT	8'-8"	C.M.U. WALL- MEZZ. FINISHED FLOOR & BELOW- PAINT FINISH
104	Women	S.CONC.	VB-4"	C.M.U./PAINT	M.R. GYP. / PAINT	M.R. GYP. / PAINT/ PCT ④	M.R. GYP. / PAINT/ PCT ④	PCAST/PAINT	8'-8"	CERAMIC TILE FINISH WALL- 6'-4" HEIGHT
105	Men	S.CONC.	VB-4"	C.M.U./PAINT	M.R. GYP. / PAINT	M.R. GYP. / PAINT/ PCT ④	M.R. GYP. / PAINT/ PCT ④	PCAST/PAINT	8'-8"	PORCELAIN TILE ON PLUMBING & SOUTH WALL
106	Utility Room	S.CONC.	VB-4"	GYP./PAINT	GYP./PAINT	C.M.U./PAINT	C.M.U./PAINT	PCAST/PAINT	8'-8"	PORCELAIN TILE ON PLUMBING & SOUTH WALL

FINISH LEGEND

DRYWALL / PAINTING / WALL FINISHES:

GYP./PAINT- PAINT ON FINISHED/ PREP'D GYP. FINISHED SURFACE.
M.R.GYP./PAINT- PAINT ON FINISHED/ PREP'D GYP. FINISHED SURFACE.
MOISTURE-RESISTANT GYP BOARD

PCT- PORCELAIN CERAMIC TILE OVER 5/8" THICKNESS
CEMENT BOARD

FLOORING:

S. CONC.- POLISHED, SEALED CONCRETE FINISH
PCT- PORCELAIN CERAMIC TILE

CEILINGS:

PCAST/PAINT- PRECAST CONCRETE PLANK CEILING. MEDIUM TEXTURE & PAINT
MTL BLDG.- INSULATION SYSTEM & STEEL FRAME OF METAL BUILDING

BASE:

VB-4" 4" VINYL BASE

KEYED NOTES











- 1 METAL BUILDING WALL TO RECEIVE 8'-0" HEIGHT PAINTED 3/4" A-C PLYWOOD
- 2 METAL BUILDING LINER PANEL ABOVE PLYWOOD
- 3 C.M.U. WALL- MEZZ. FINISHED FLOOR & BELOW- PAINT FINISH
- 4 CERAMIC TILE FINISH WALL- 6'-4" HEIGHT

FINISH NOTES


- 1 PATCH AND REPAIR ALL EXISTING WALL AND CEILING SURFACES AS NECESSARY.
ALL SURFACES WHICH ARE TO RECEIVE FINISH APPLICATION WILL BE SMOOTH, FREE FROM DEPRESSIONS, PROTRUSIONS, PITS, BUMPS, STREAKS AND VARIATION IN TEXTURE. IF SURFACES ARE NOT ACCEPTABLE TO RECEIVE FINISHES, NOTIFY GENERAL CONTRACTOR AND HAVE SURFACES CORRECTED PRIOR TO FINISH APPLICATION.
- 2 ALL SURFACES DESIGNATED TO BE PAINTED SHALL RECEIVE MEDIUM-ORANGE PEEL SPRAY TEXTURE COAT AND TWO WELL-APPLIED FINISH COATS TO PROPERLY COVER SURFACE.
- 3 ALL WALL PAINT TO BE SATIN FINISH. ALL TRIM WHERE APPLICABLE TO BE SEMI-GLOSS. CEILINGS TO BE FLAT FINISH. CONTRACTOR TO PROVIDE TOP-QUALITY LATEX PAINTS FROM THE APPROVED PAINT MANUFACTURER. 3-COATS: PRIMER-TEXTURE & 2 COATS PAINT PROCESS TO BE APPLIED.
- 4 STEEL DOOR FRAMES TO BE PAINTED SMOOTH, SEMI-GLOSS FINISH. FRAMES TO RECEIVE 3-COATS: PRIMER & 2 COATS PAINT PROCESS TO BE APPLIED.
- 5 ALL MISCELLANEOUS GRILLES, ETC. OCCURRING ON WALLS OR CEILING SHALL BE PAINTED TO MATCH THE SURFACES ON WHICH THEY OCCUR UNLESS OTHERWISE NOTED. ALL METAL SURFACES SHALL BE PRIMED FOR PAINTING AND PAINTED WITH 2 COATS PAINT FINISH.

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PROJECT:		Norwalk Area Fire District		Norwalk, WI		212 Main Street	Monroe County
New Fire Station		212 Main Street		Norwalk, WI 54648		DATE: November 19, 2025	SHEET NUMBER:

A2.1 Schedules / Interior Details

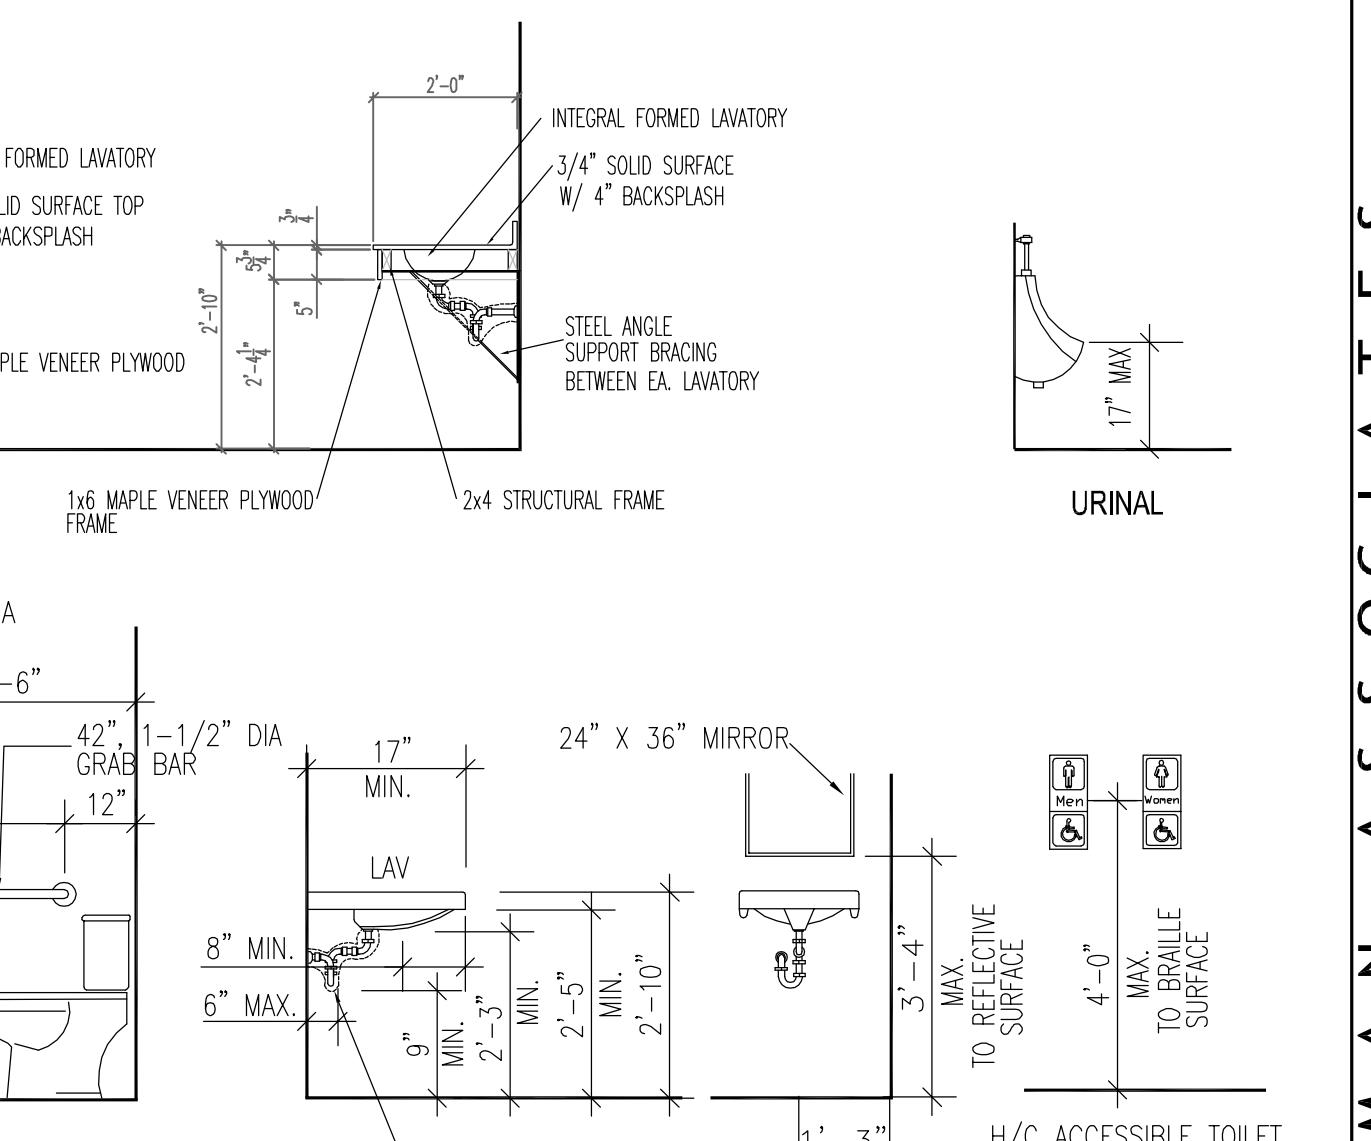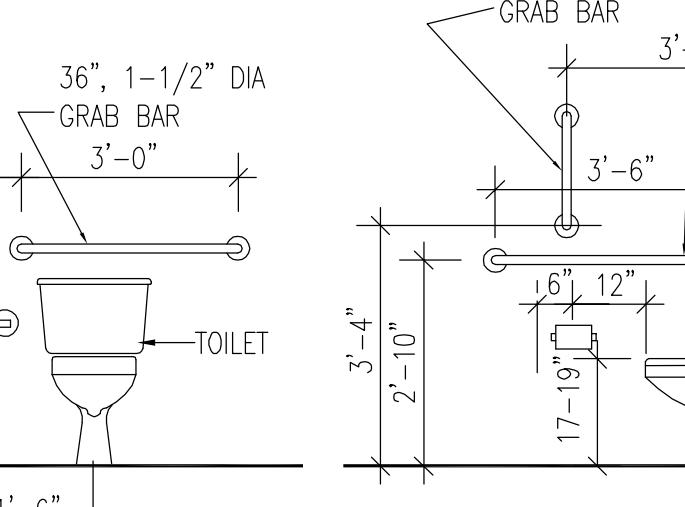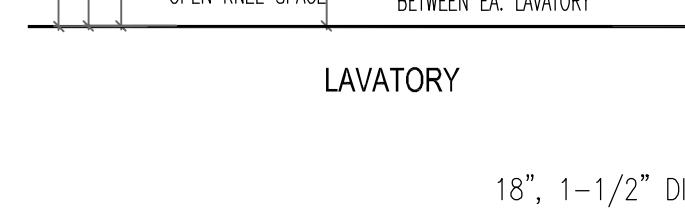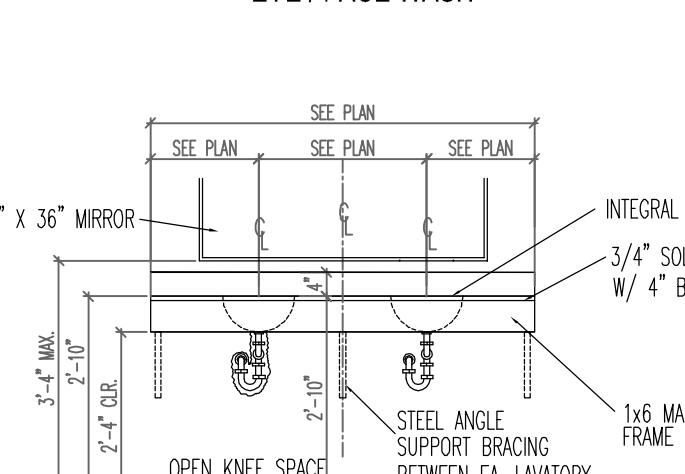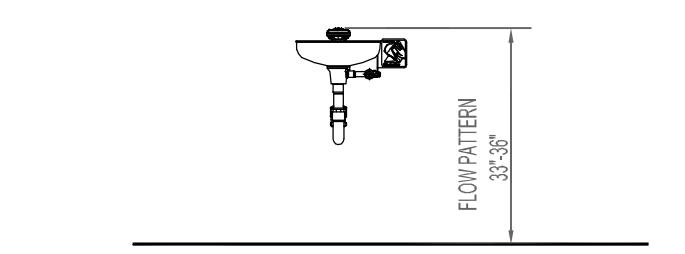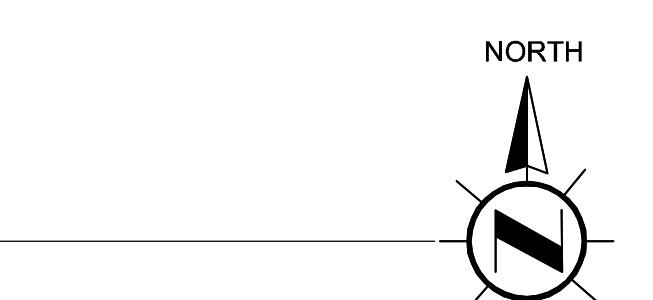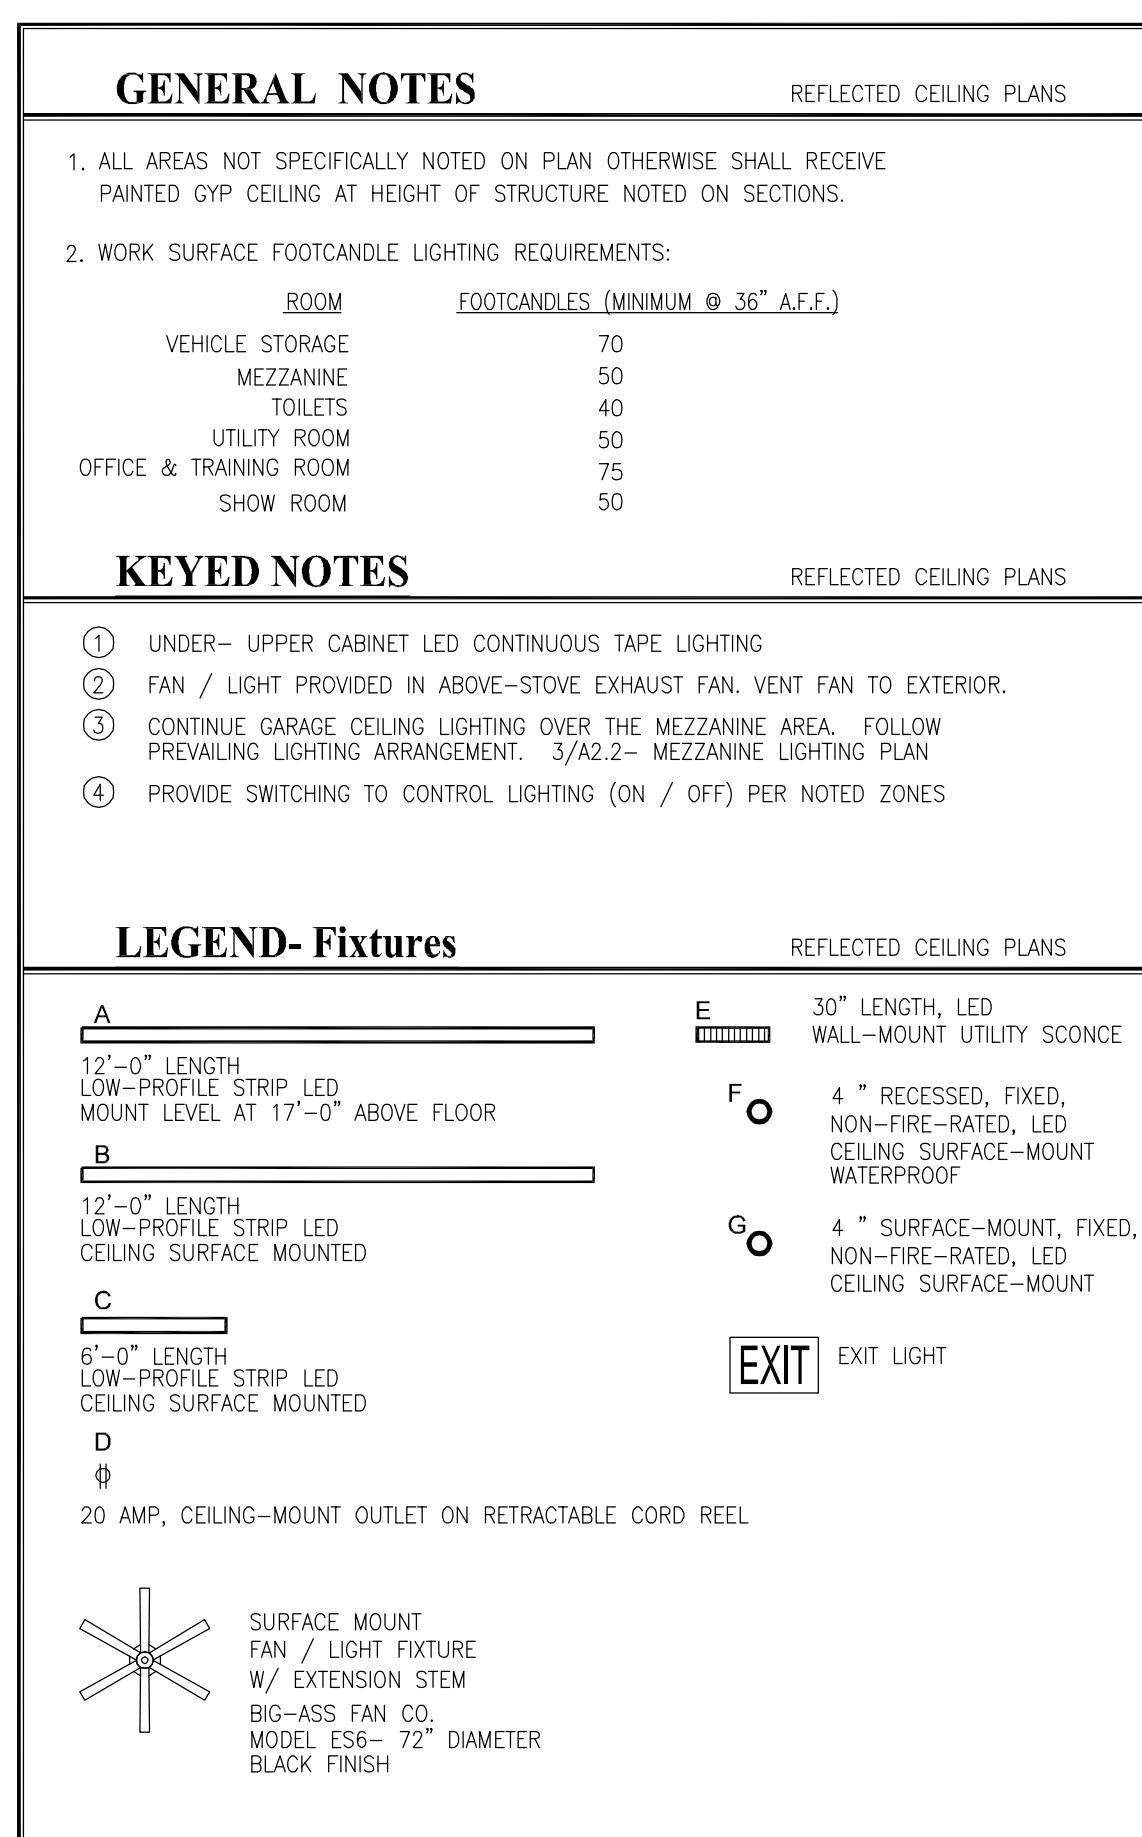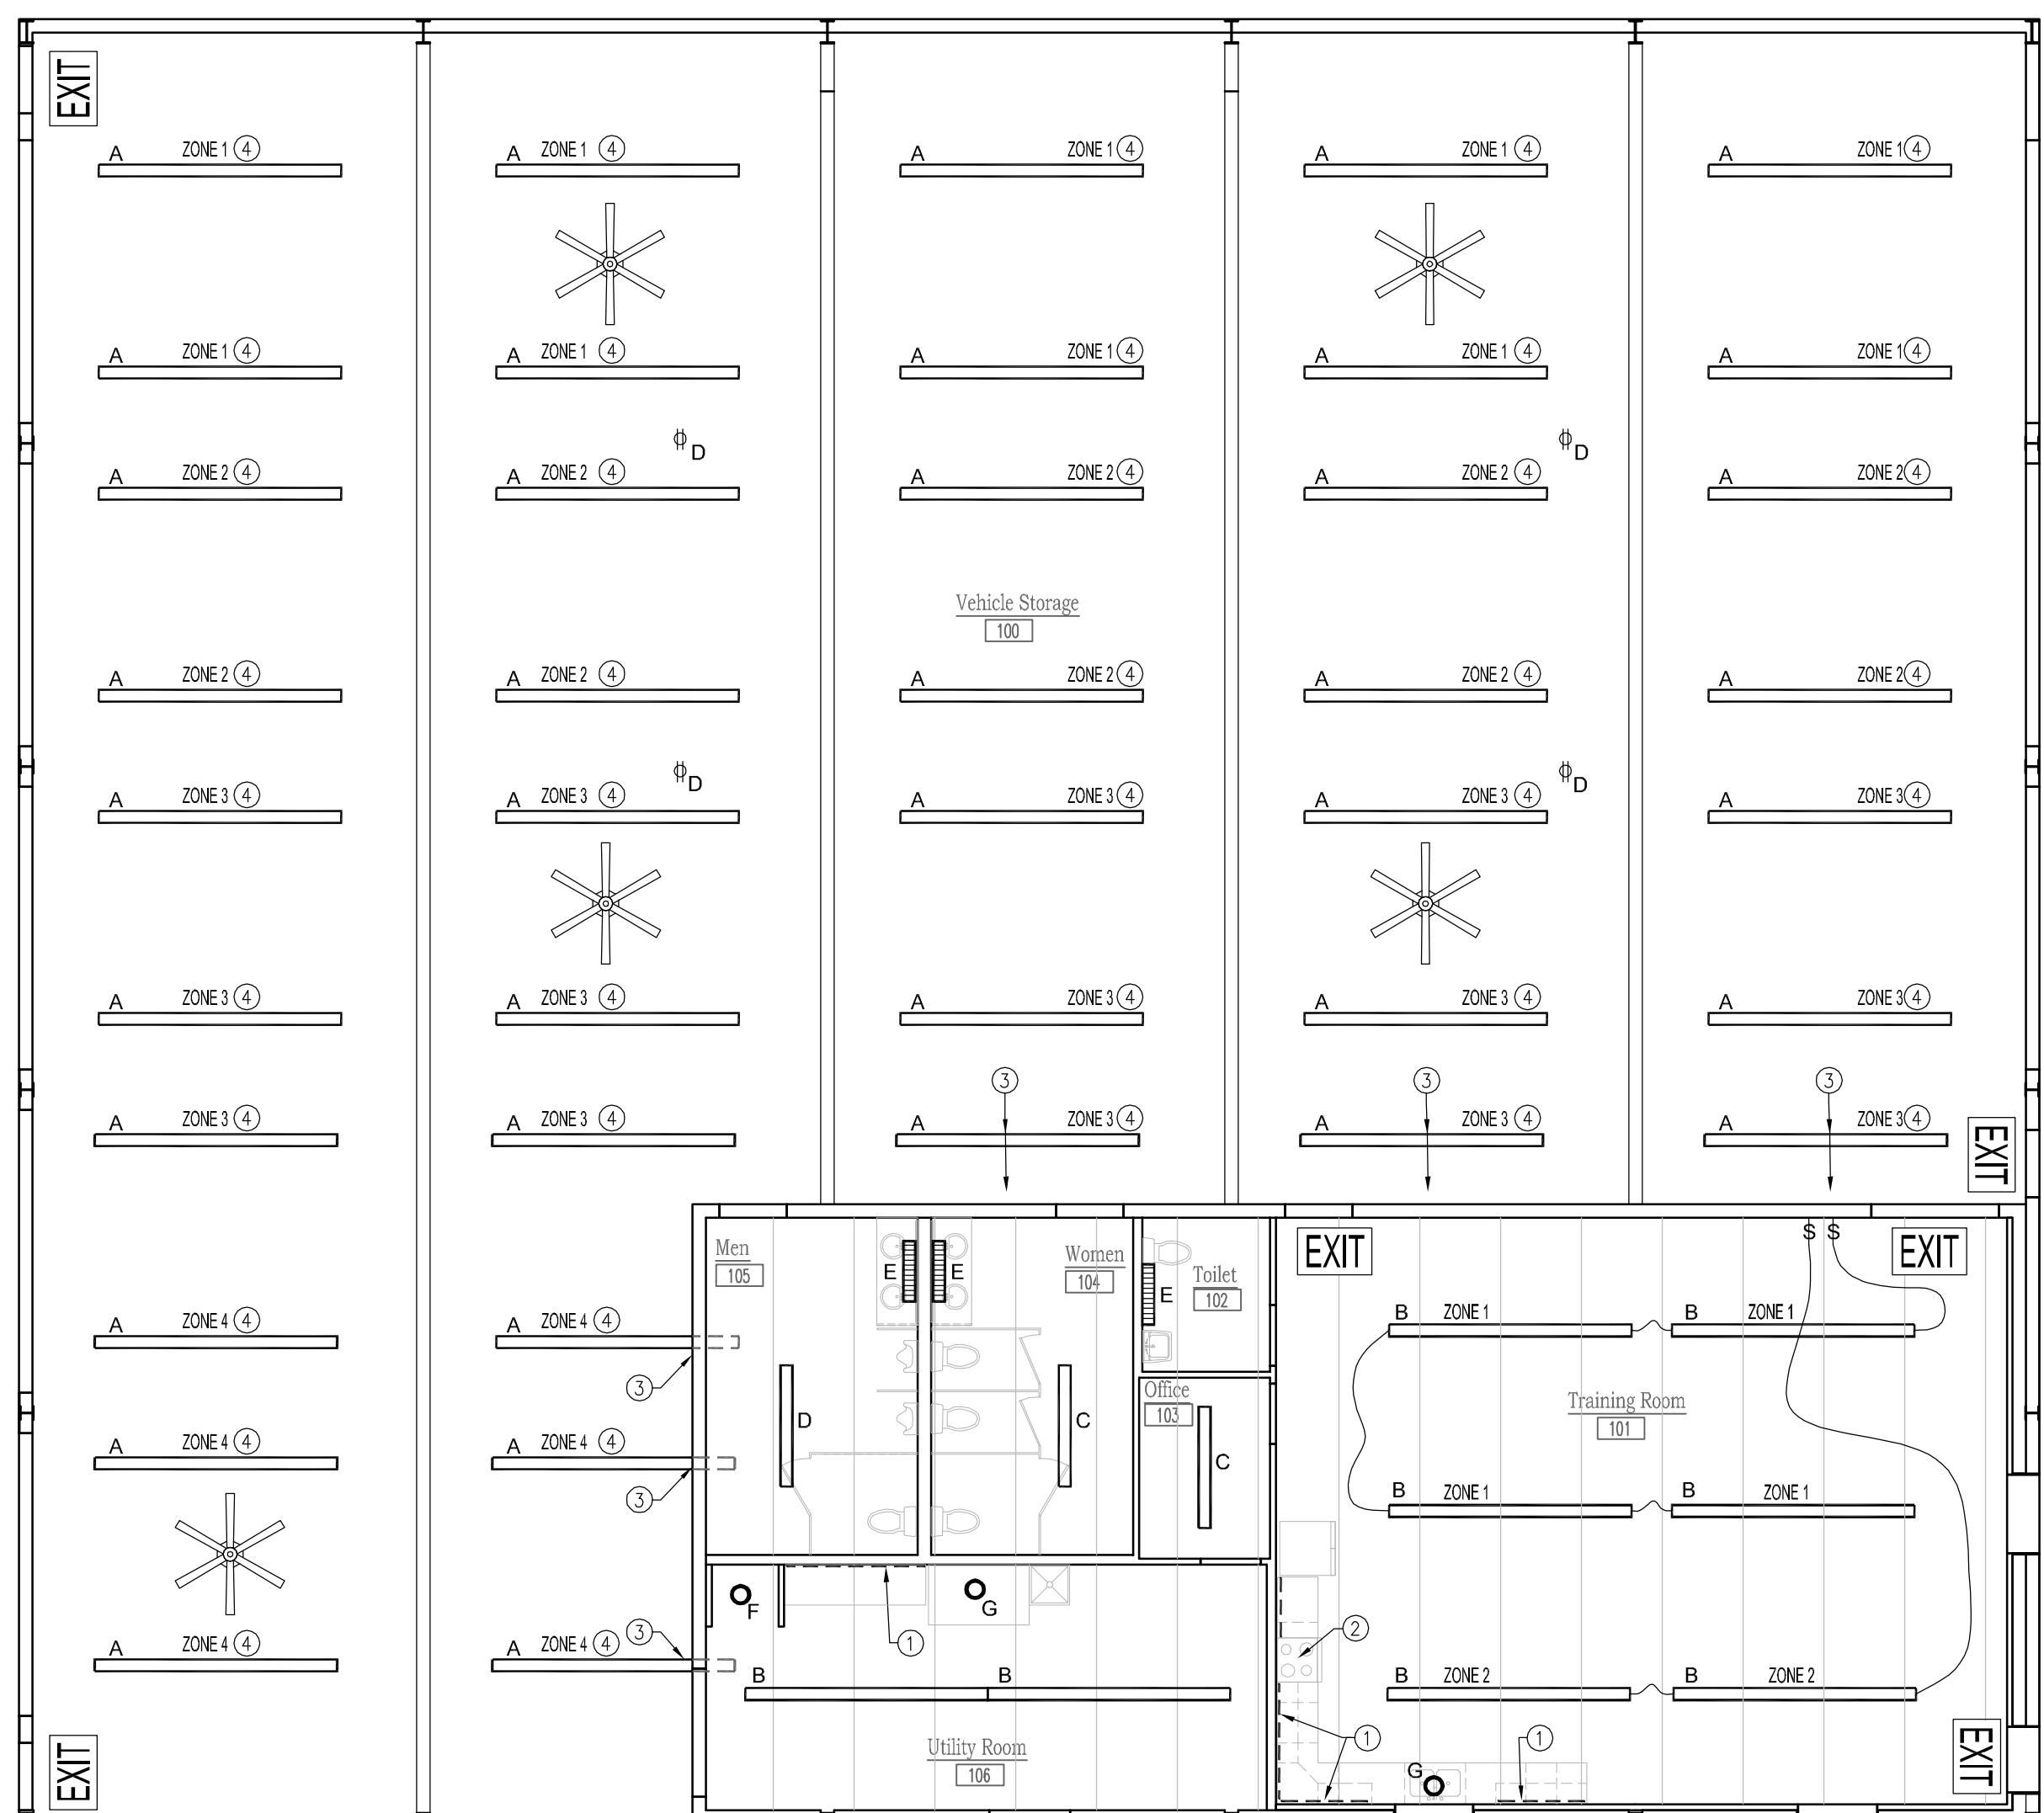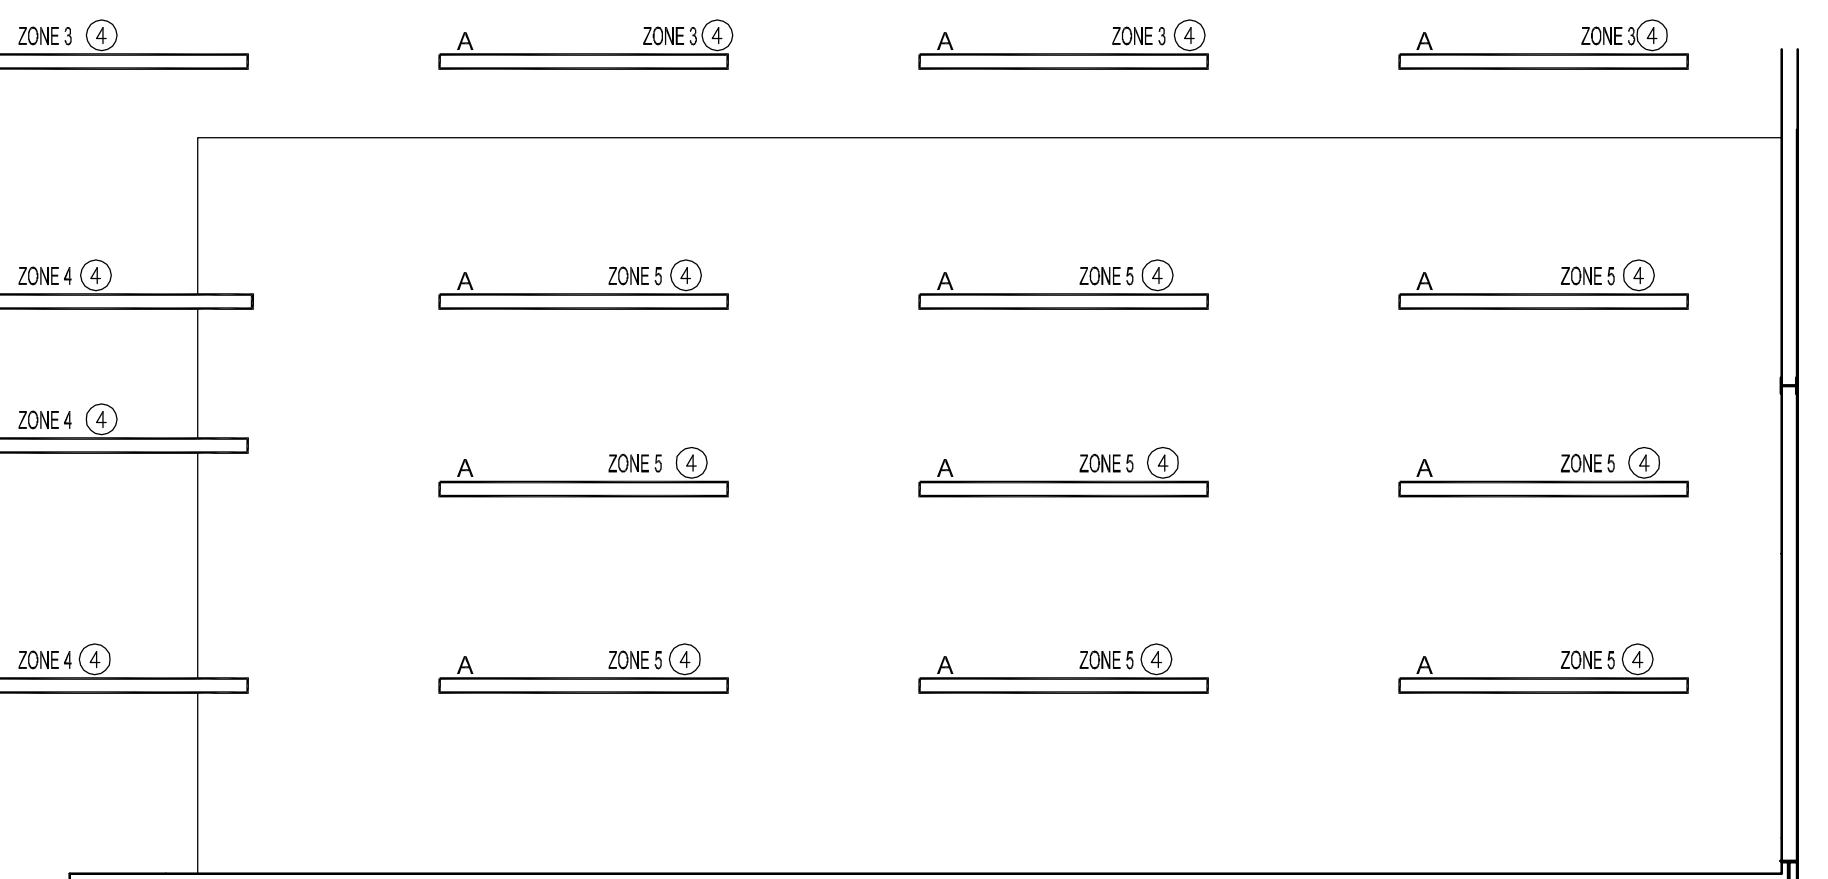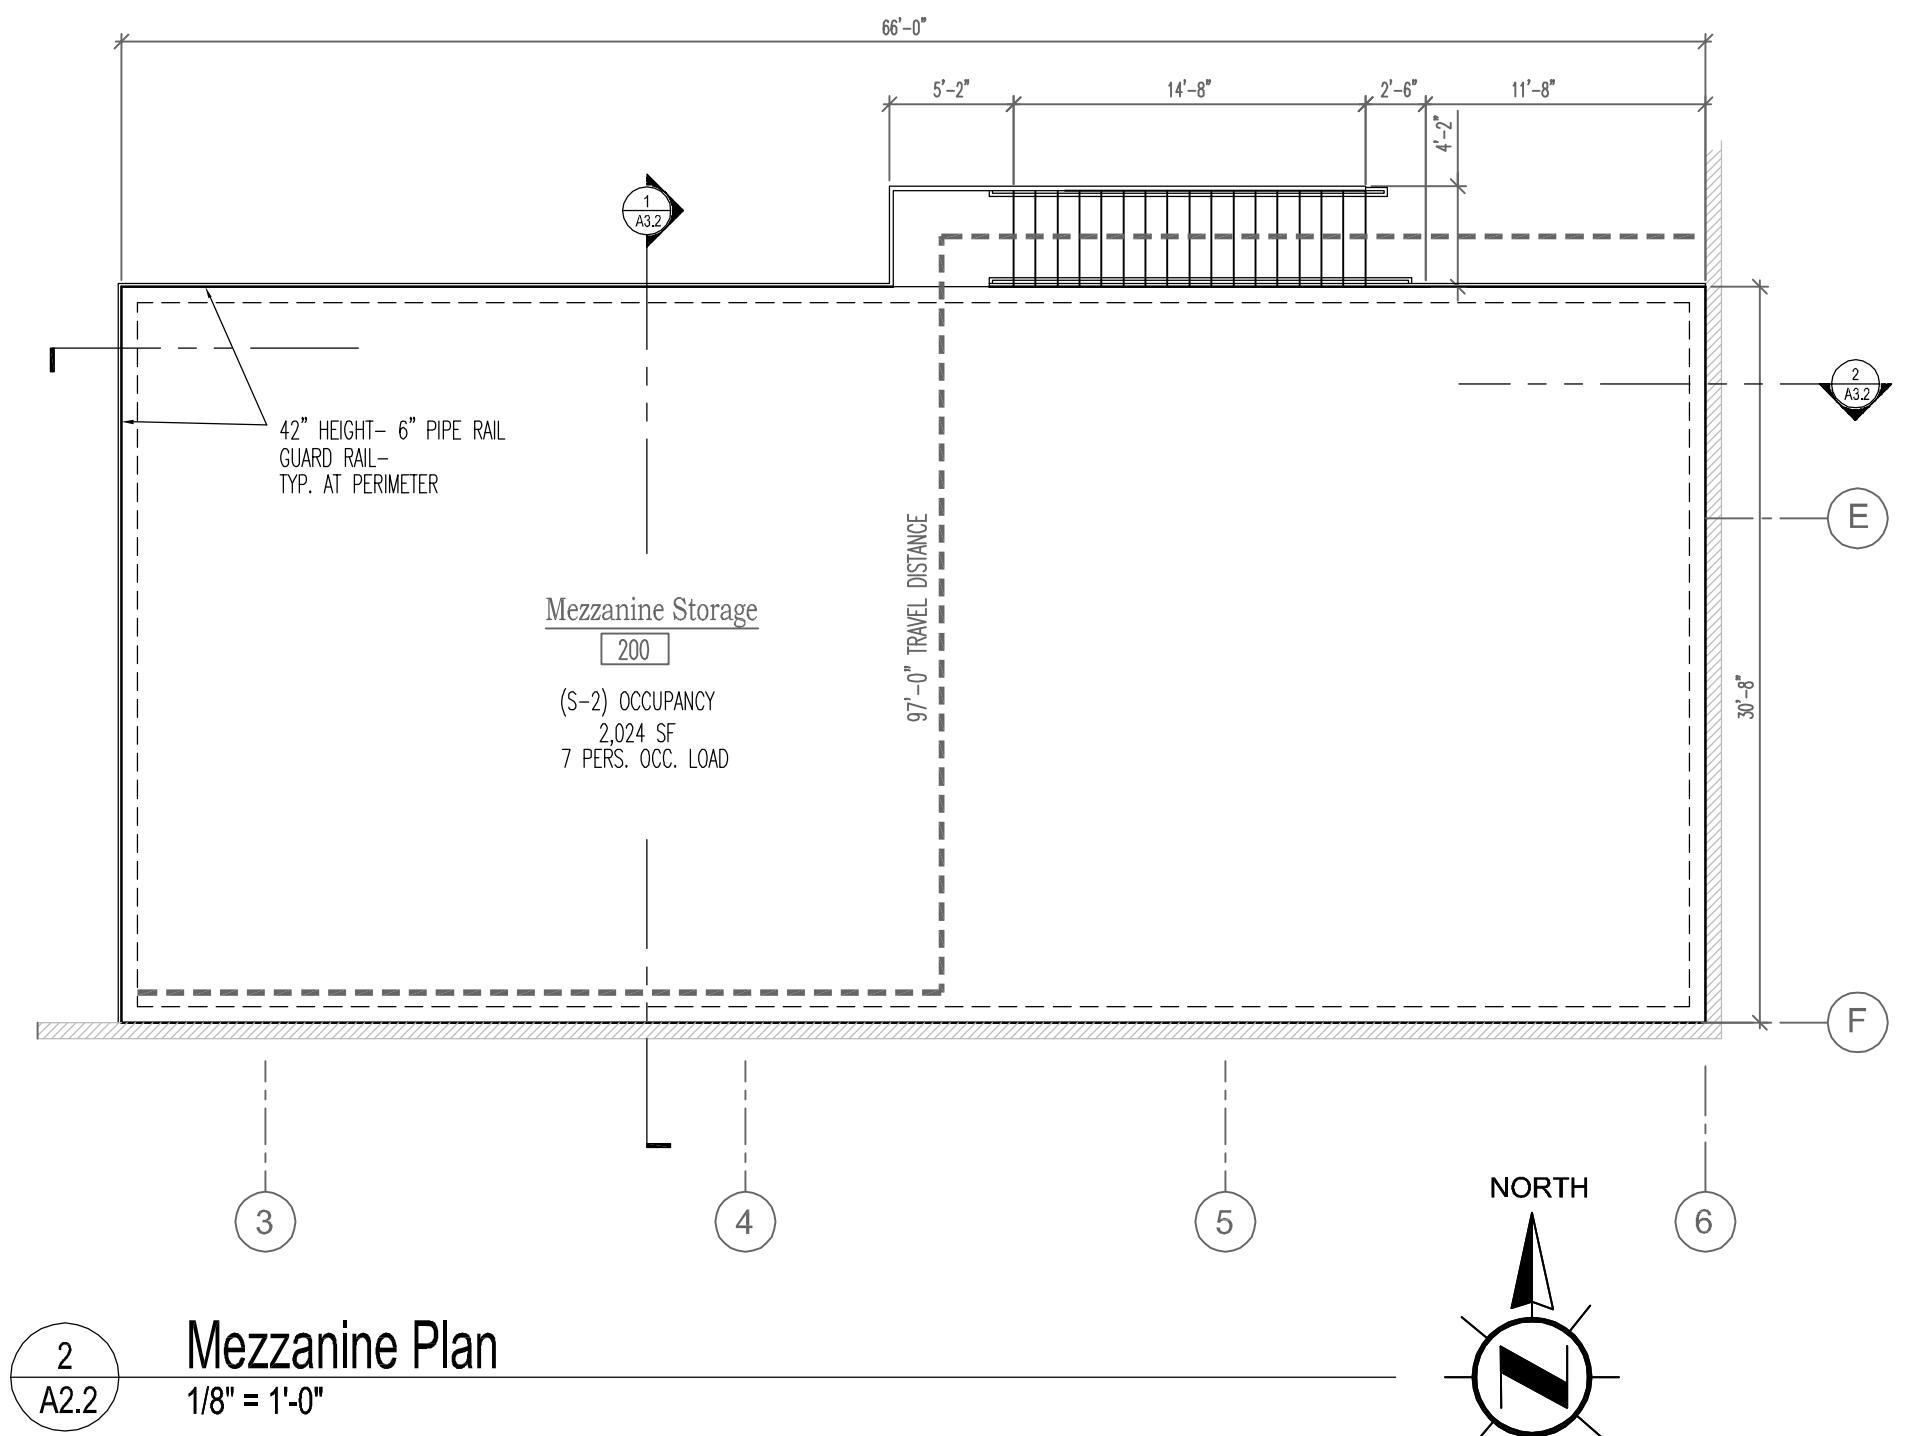


PROTECTION OF EXPOSED P

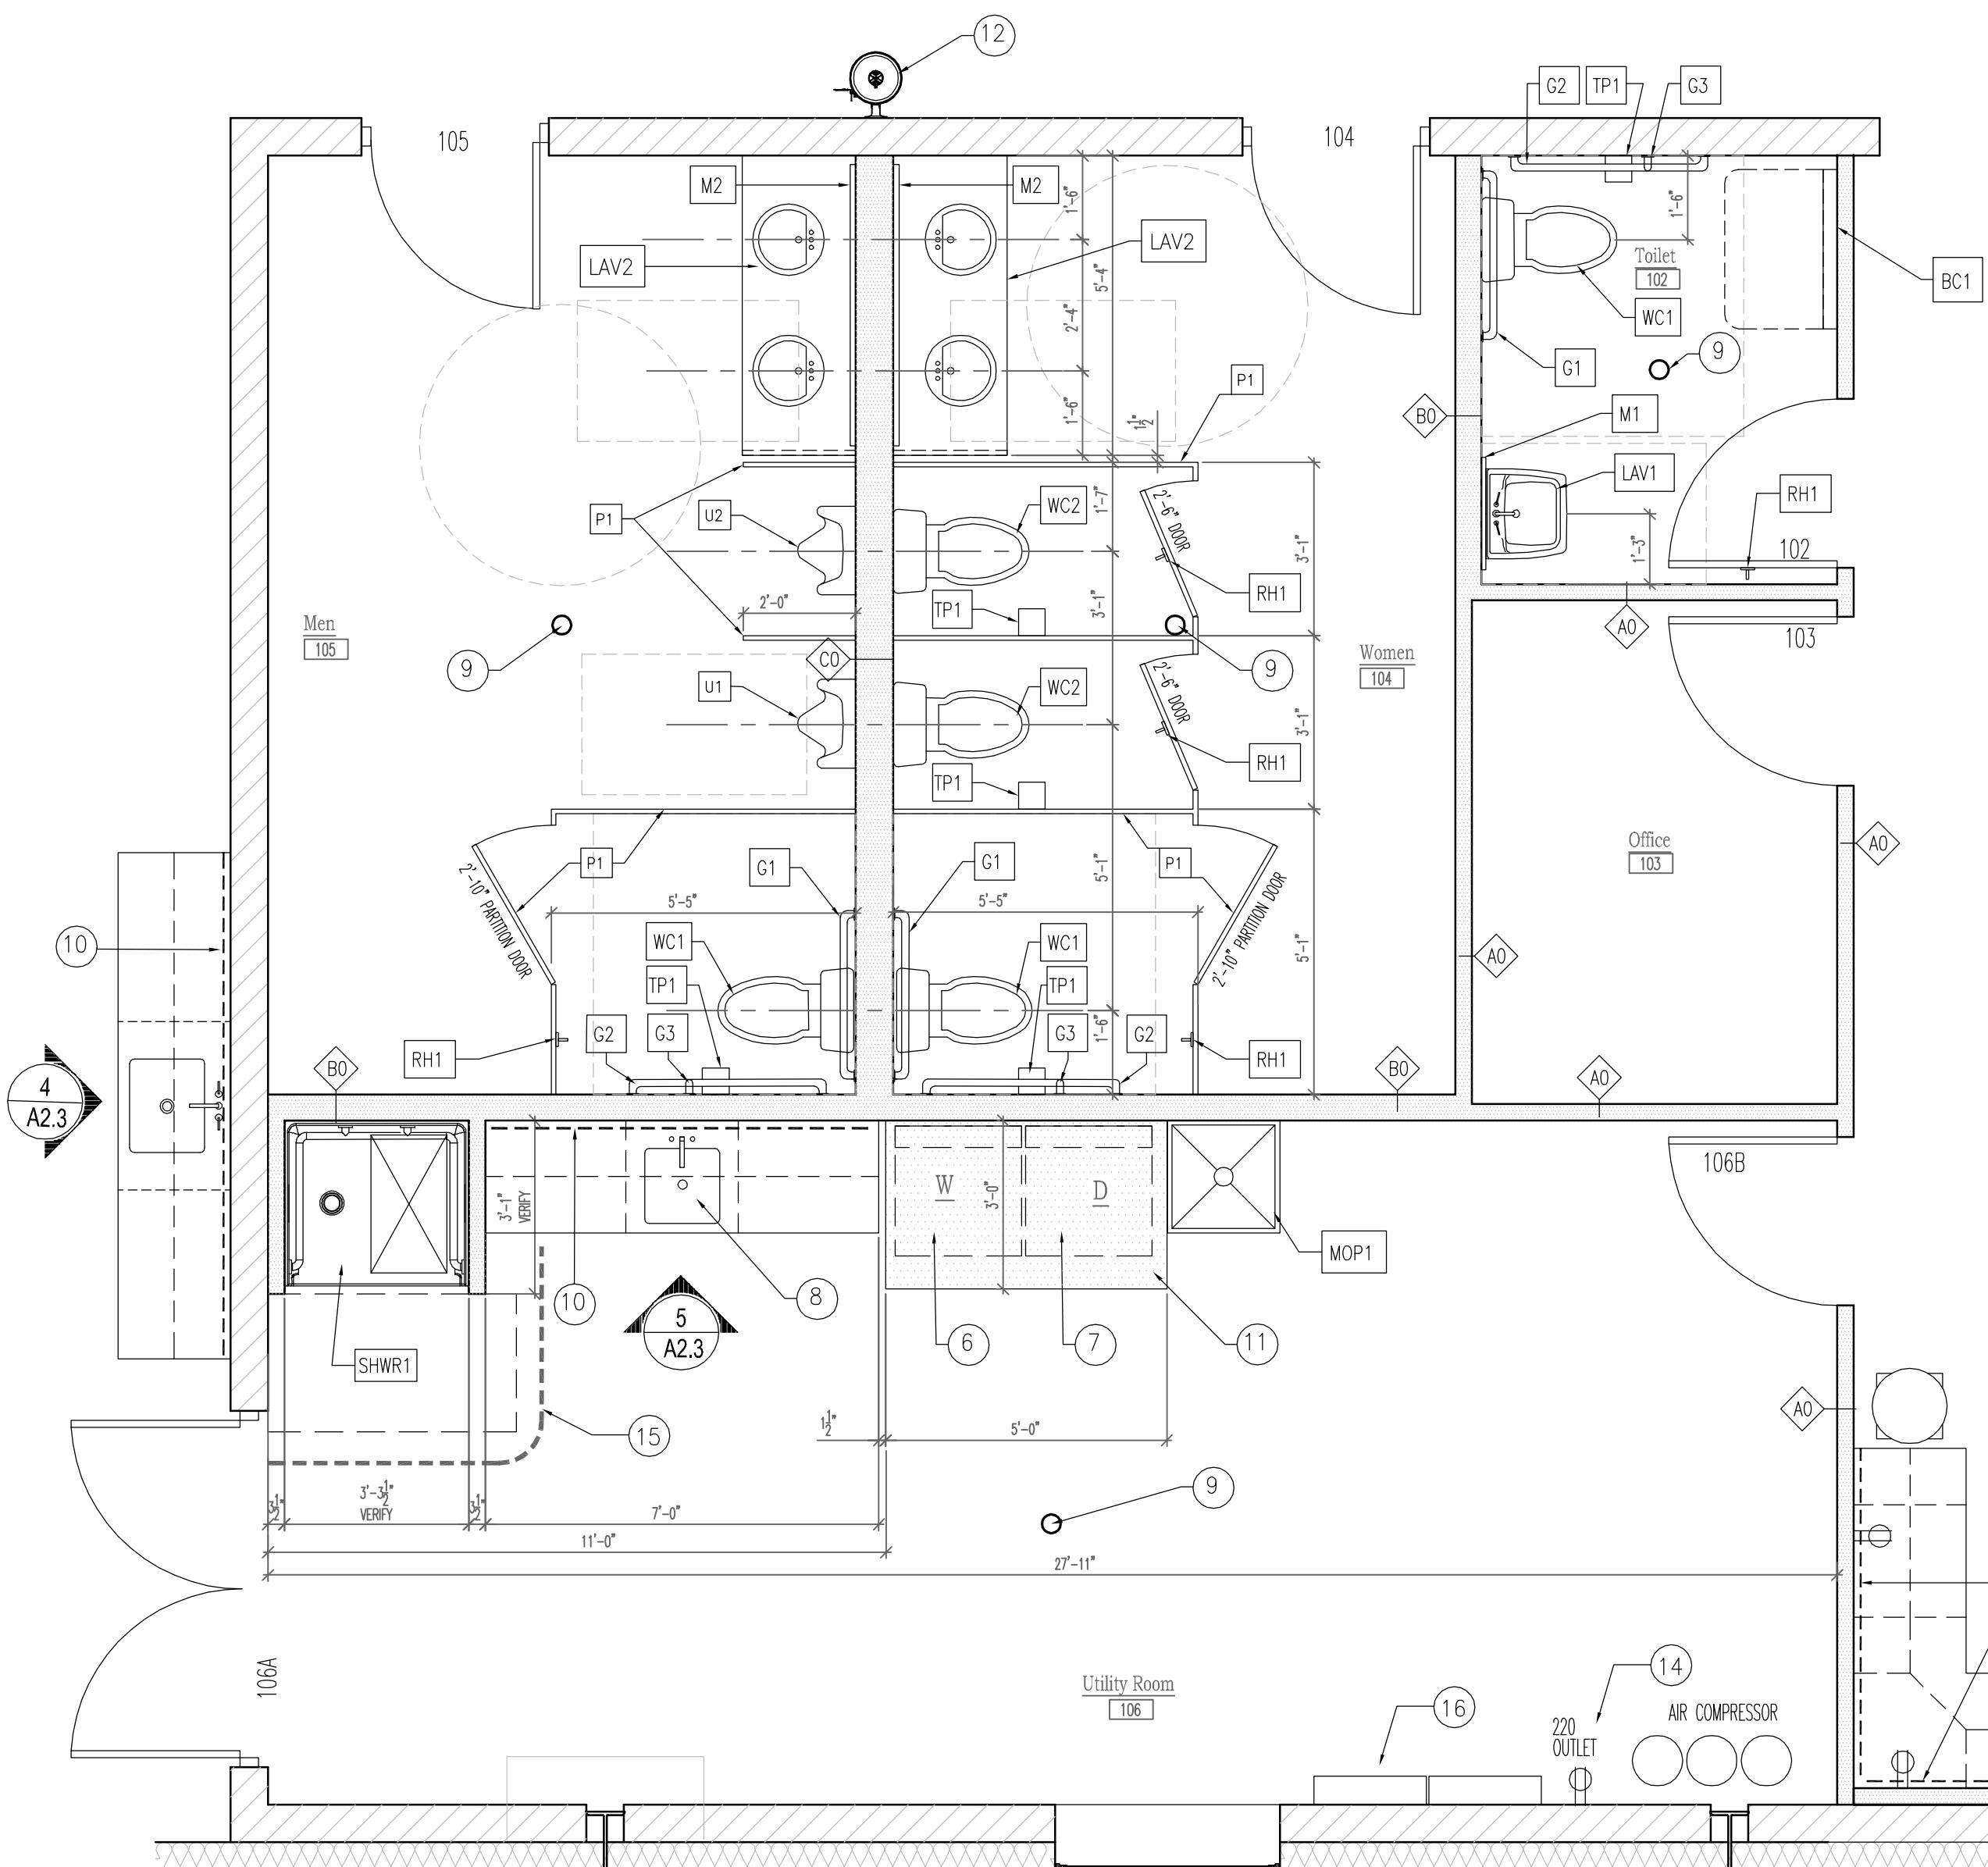

KEYED NOTES

- (1) RESIDENTIAL-GRADE STOVE- FRONT CONTROLS
- (2) STOVE EXHAUST HOOD- VENT TO EXTERIOR
- (3) COUNTERTOP MICROWAVE UNIT
- (4) RESIDENTIAL-GRADE REFRIGERATOR UNIT- BOTTOM FREEZER
- (5) STAINLESS STEEL DOUBLE-BASIN KITCHEN SINK
UNDER-COUNTER MOUNT
- (6) RESIDENTIAL WASHER- FRONT CONTROLS / FRONT LOAD
- (7) RESIDENTIAL DRYER- FRONT CONTROLS / FRONT LOAD
- (8) 16x16x9" DEPTH STAINLESS STEEL SINGLE-BASIN UTILITY SINK
UNDER-COUNTER MOUNT
- (9) FLOOR DRAIN
- (10) UNDER-UPPER CABINET SINGLE WHITE COLOR LED STRIP LIGHTING
- (11) 6" THICK CONCRETE SLAB - PAD FOR WASHER / DRYER
- (12) EMERGENCY EYE / FACE WASH WASH STATION
HAWS CORP MODEL 7260B-7270B: AXION MSR WALL MOUNT EYE/FACE WASH
- (13) ELECTRICAL SERVICE OUTLETS AS SHOWN- PROVIDE EACH
ON 15AMP INDIVIDUAL CIRCUITS
- (14) 220V ELECTRICAL SERVICE OUTLET FOR AIR COMPRESSOR
- (15) CEILING-MOUNT CURTAIN TRACK WITH CURTAIN
- (16) ELECTRIC SERVICE PANEL LOCATION

Enlarged Plan

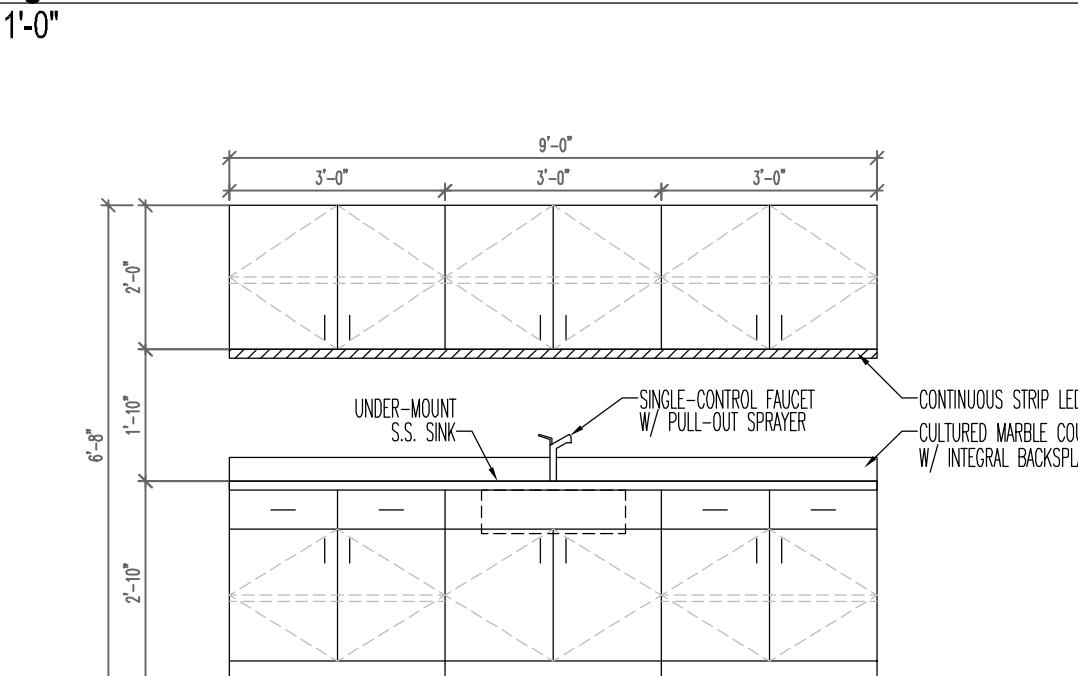


4 A2.3 Cabinetry Elevation - Vehicle Storage
3/8" = 1'-0"


FIXTURES & ACCESSORIES SCHEDULE

SEE 3 / A2.2 FOR STANDARD MOUNTING HEIGHTS


TAG	DESCRIPTION
G1	36" GRAB BAR- 1-1/2" DIA
G2	42" GRAB BAR- 1-1/2" DIA
G3	18" VERTICAL GRAB BAR- 1-1/2" DIA
RH1	ROBE HOOK- DOOR MOUNTED
TP1	TOILET PAPER DISPENSER - WALL / PARTITION MOUNT
M1	24" W x 36" H PLATE GLASS MIRROR W/ CHROME FRAME
M2	48" W x 36" H PLATE GLASS MIRROR W/ CHROME FRAME
LAV1	ADA ACCESS WALL-MOUNT LAVATORY
LAV2	MOLDED CULTURED MARBLE LAVATORY / COUNTERTOP SET IN WALL-MOUNTED, OPEN-KNEE CLEARANCE BASE MAX. FINISHED COUNTERTOP HEIGHT= 34" A.F.F. SEE VANITY DETAIL 4 / A2.6
WC1	ADA ACCESS ELONGATED BOWL TANK TOILET
WC2	STANDARD HEIGHT ELONGATED BOWL TANK TOILET
U1	ADA MOUNTING HEIGHT URINAL
U2	STANDARD MOUNTING HEIGHT URINAL
SHWR1	ACCESSIBLE, 36" CLEAR DEPTH X 36" CLEAR WIDTH TRANSFER SHOWER UNIT. EQUIP WITH GRAB BARS AND SEAT PER ADA REQUIREMENTS. INSTALL ADA SLIDE BAR / REMOVABLE SHOWER HEAD W/ HOSE
MOP1	24" x 24" MOLDED FLOOR-MOUNT MOP SINK
BC1	ACCESSIBLE BABY-CHANGING STATION
P1	PHENOLIC RESIN TOILET PARTITION

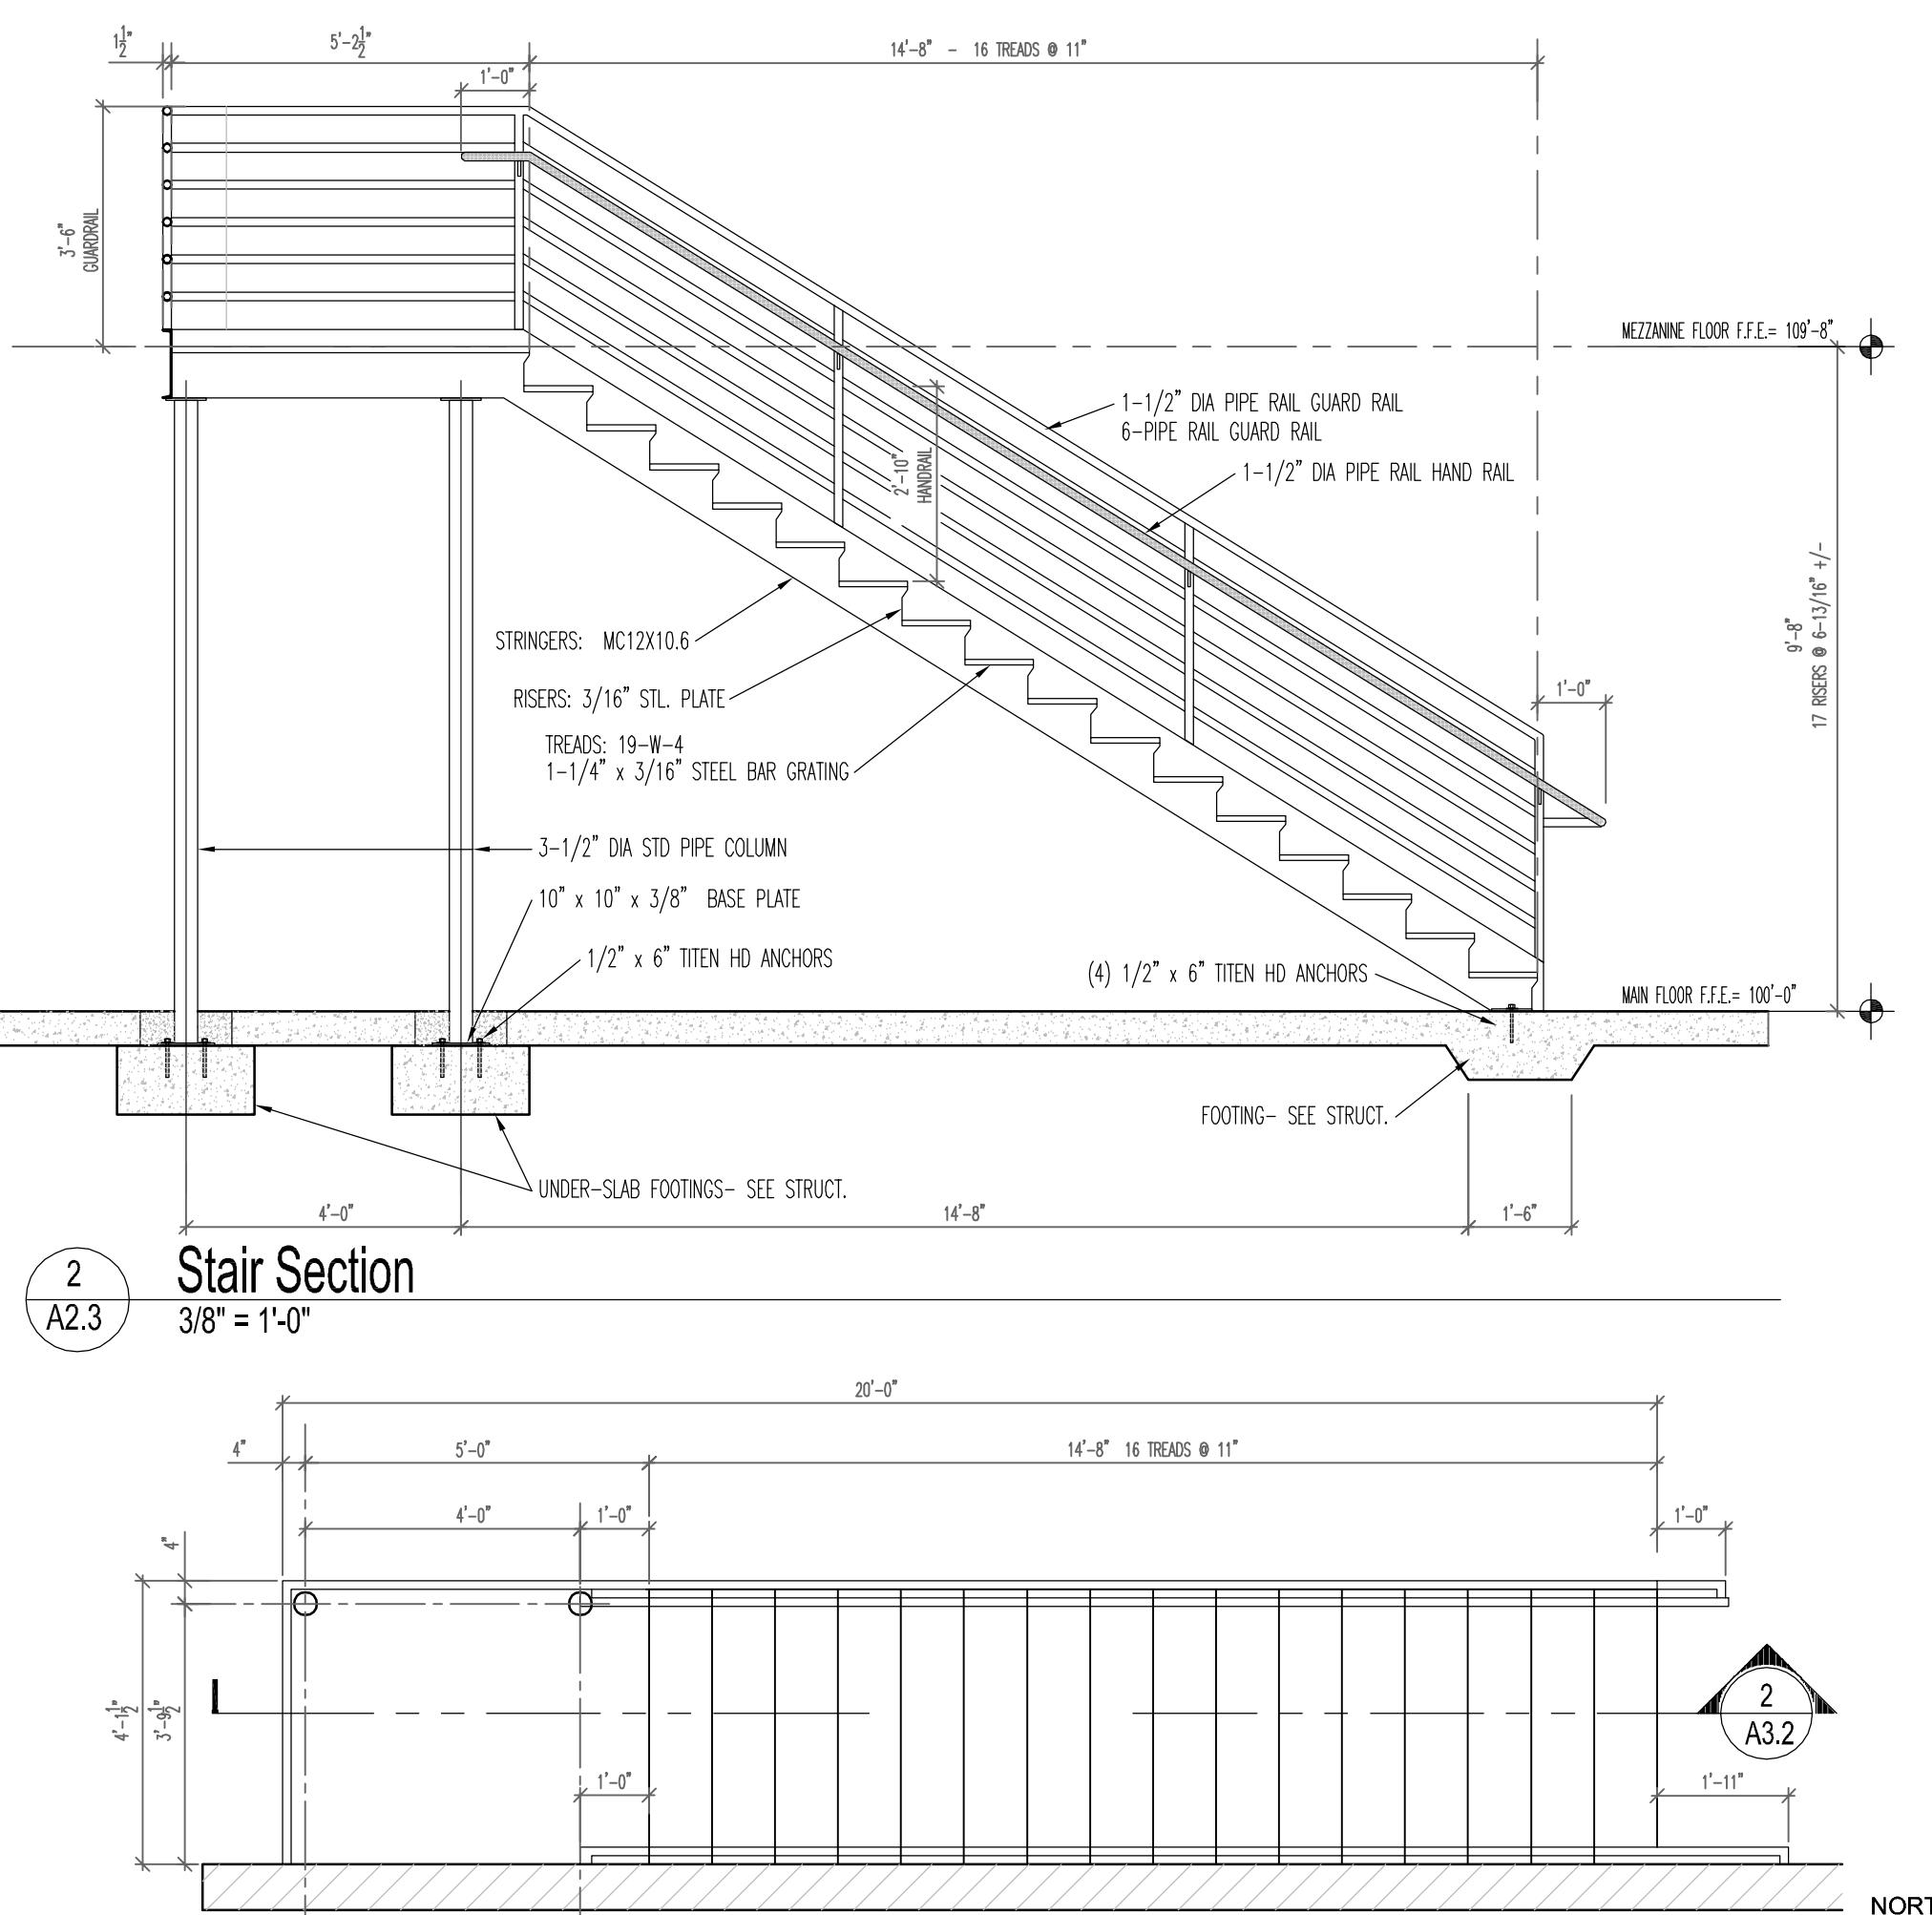

Stair Detail

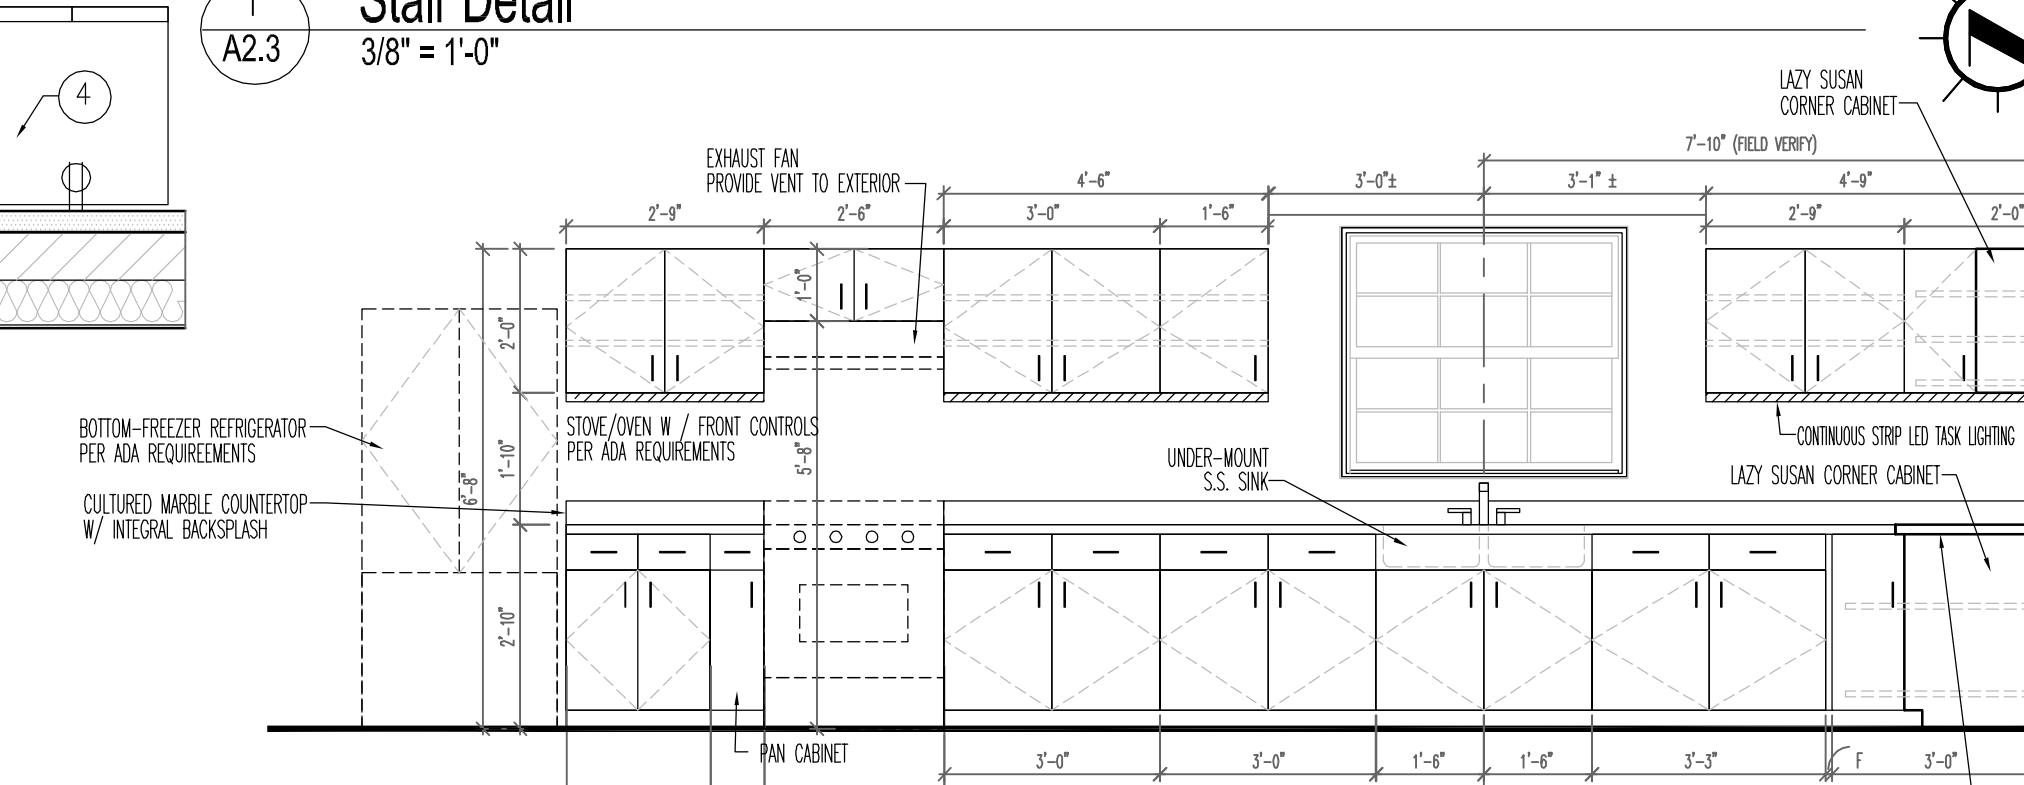





Cabinetry Elevation - Training Room

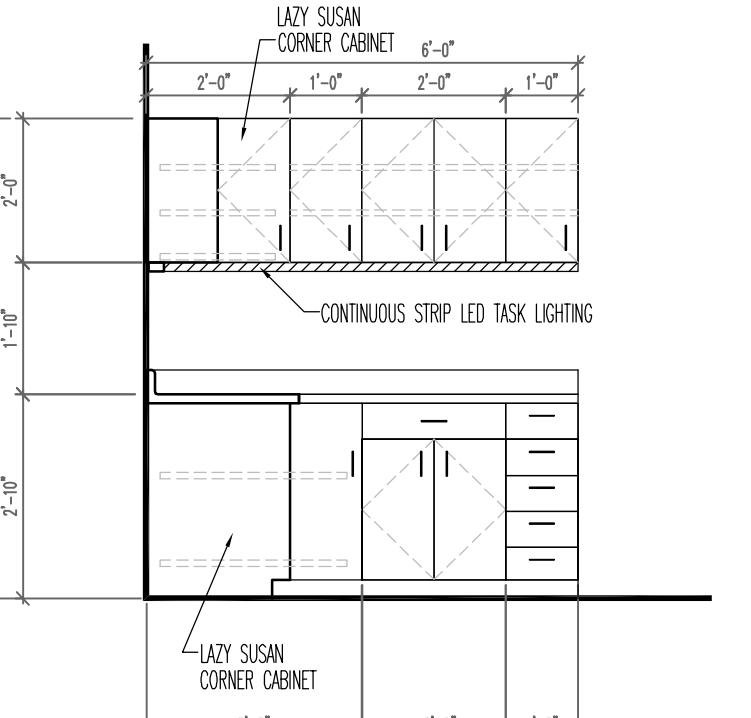

7 A2.3 Cabinetry Elevation- Training Room
3/8" = 1'-0"


5 A2.3 Cabinetry Elevation- Utility Room
3/8" = 1'-0"

4 A2.3 Cabinetry Elevation - Vehicle Storage
3/8" = 1'-0"

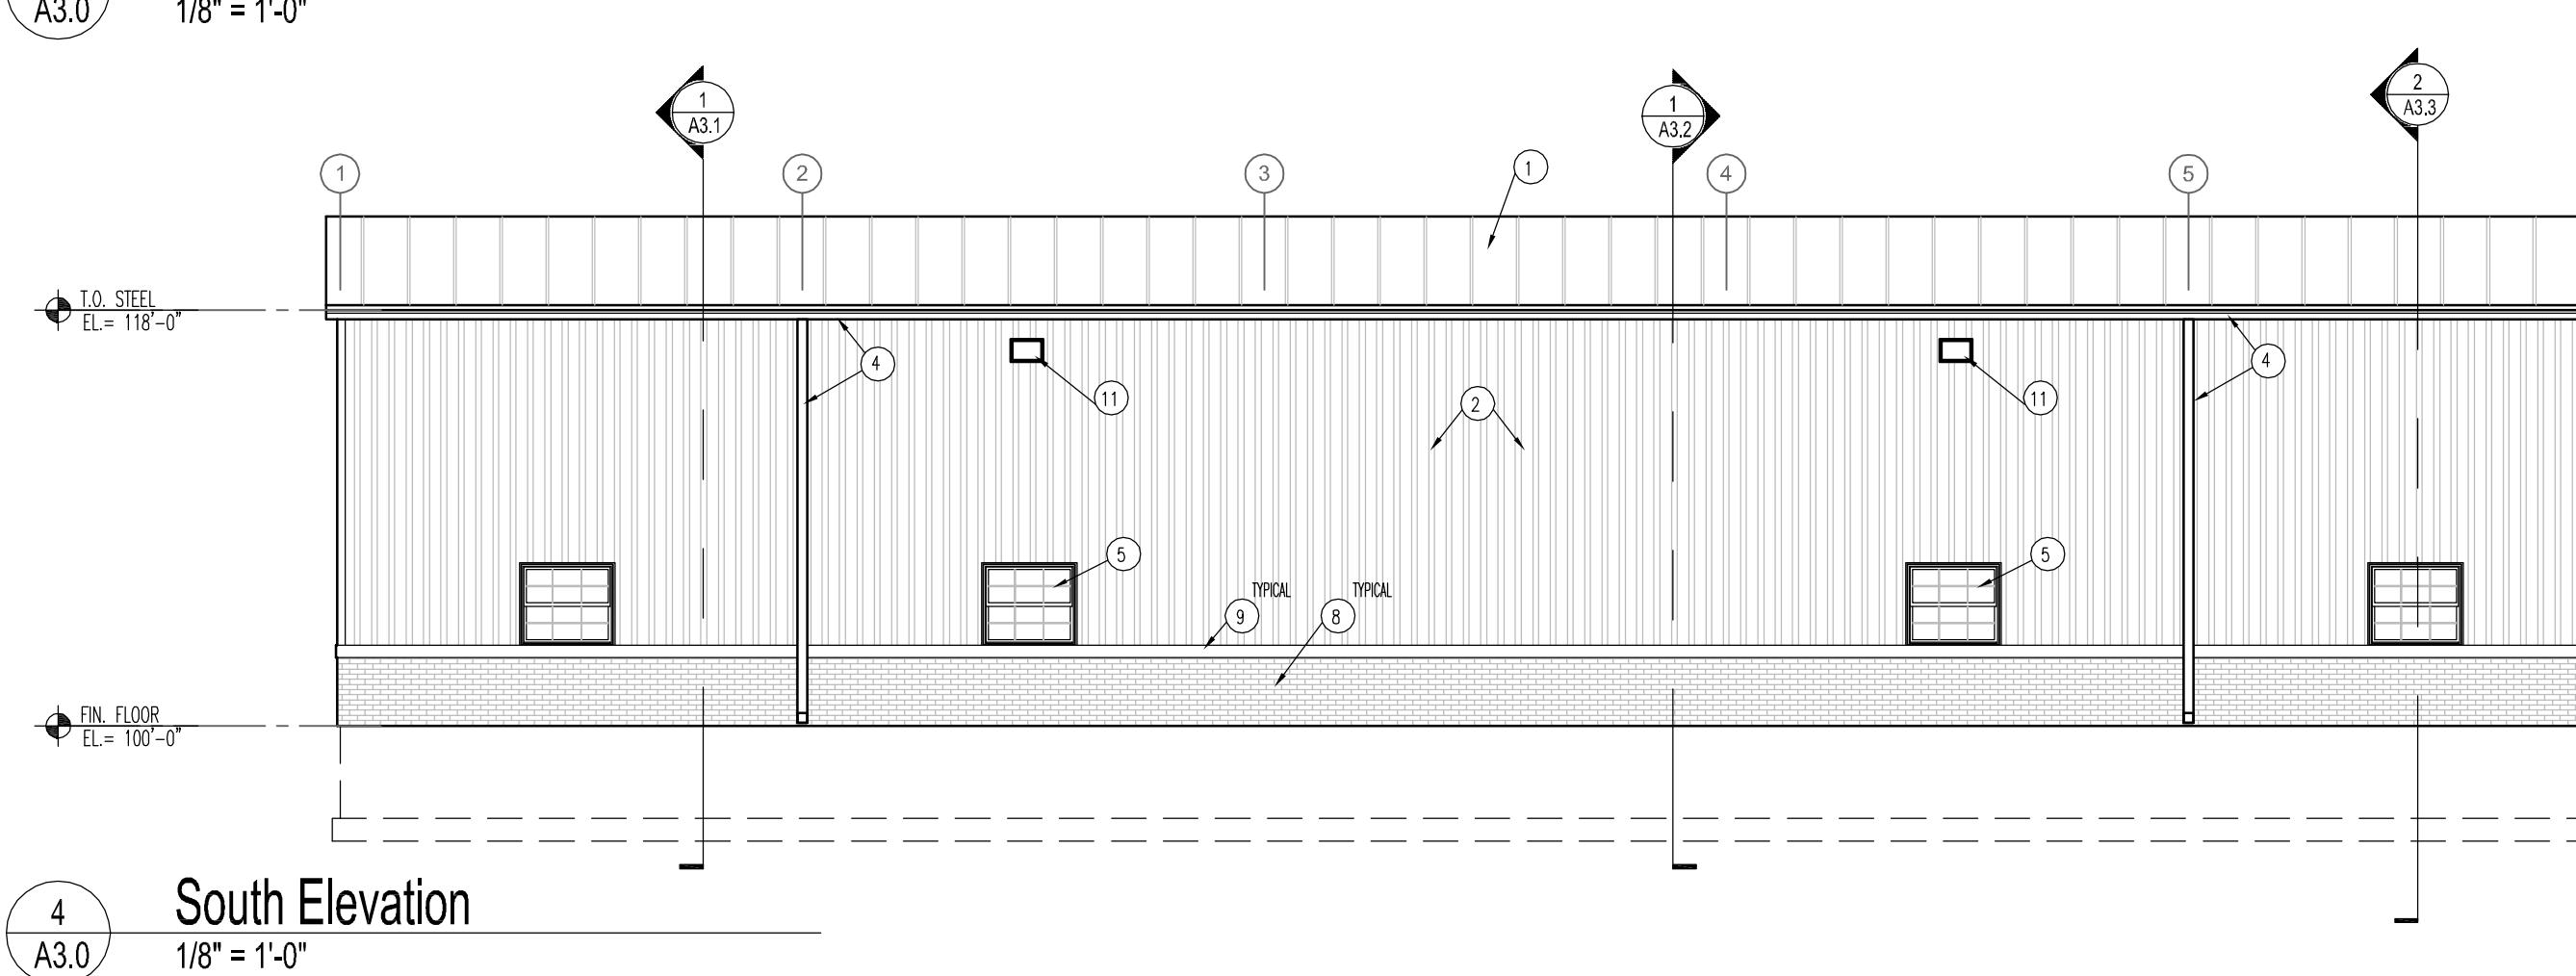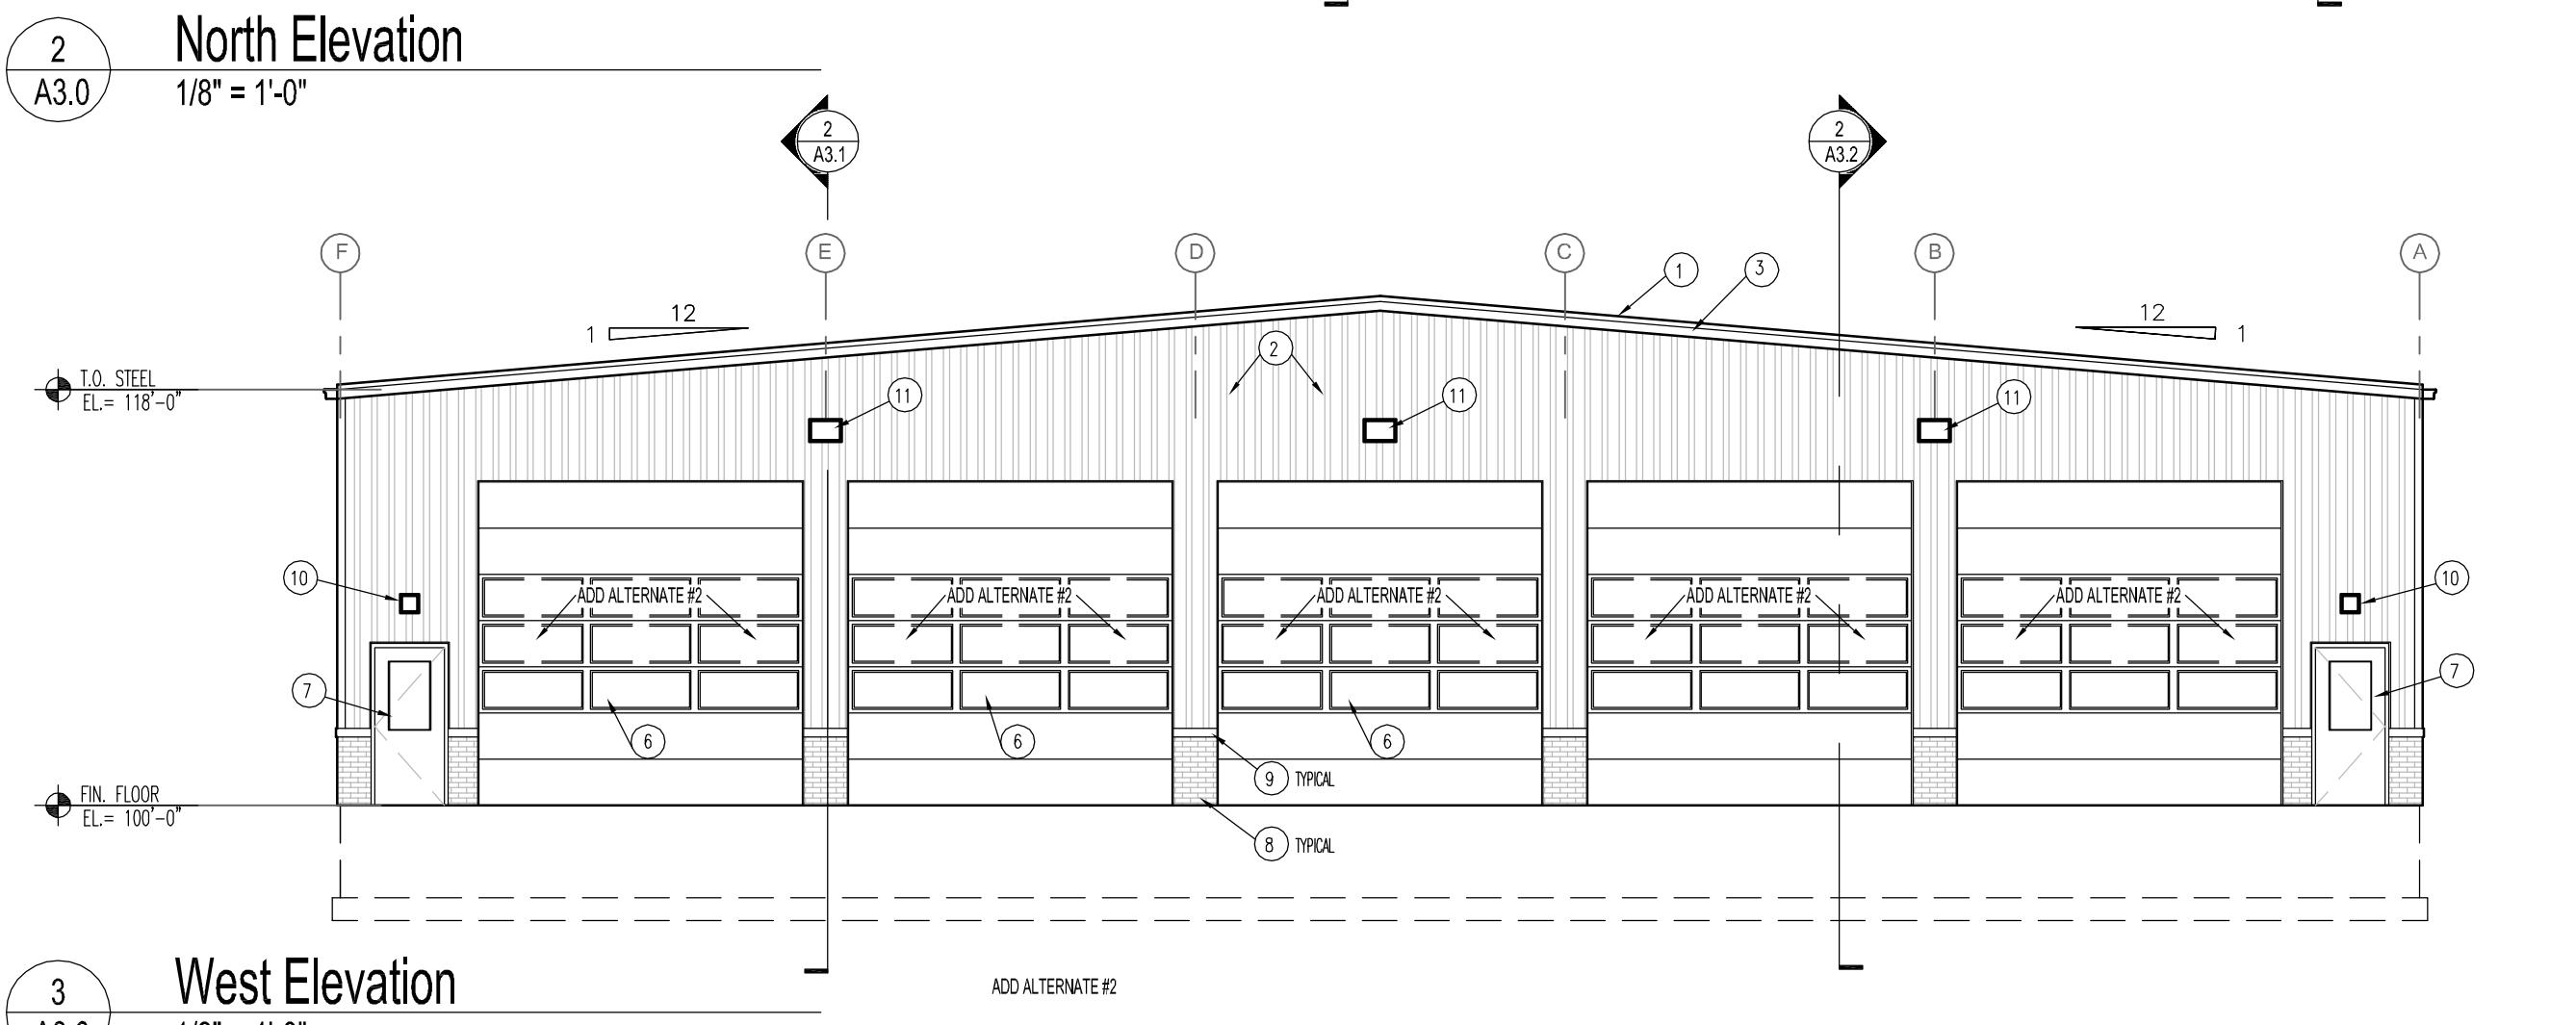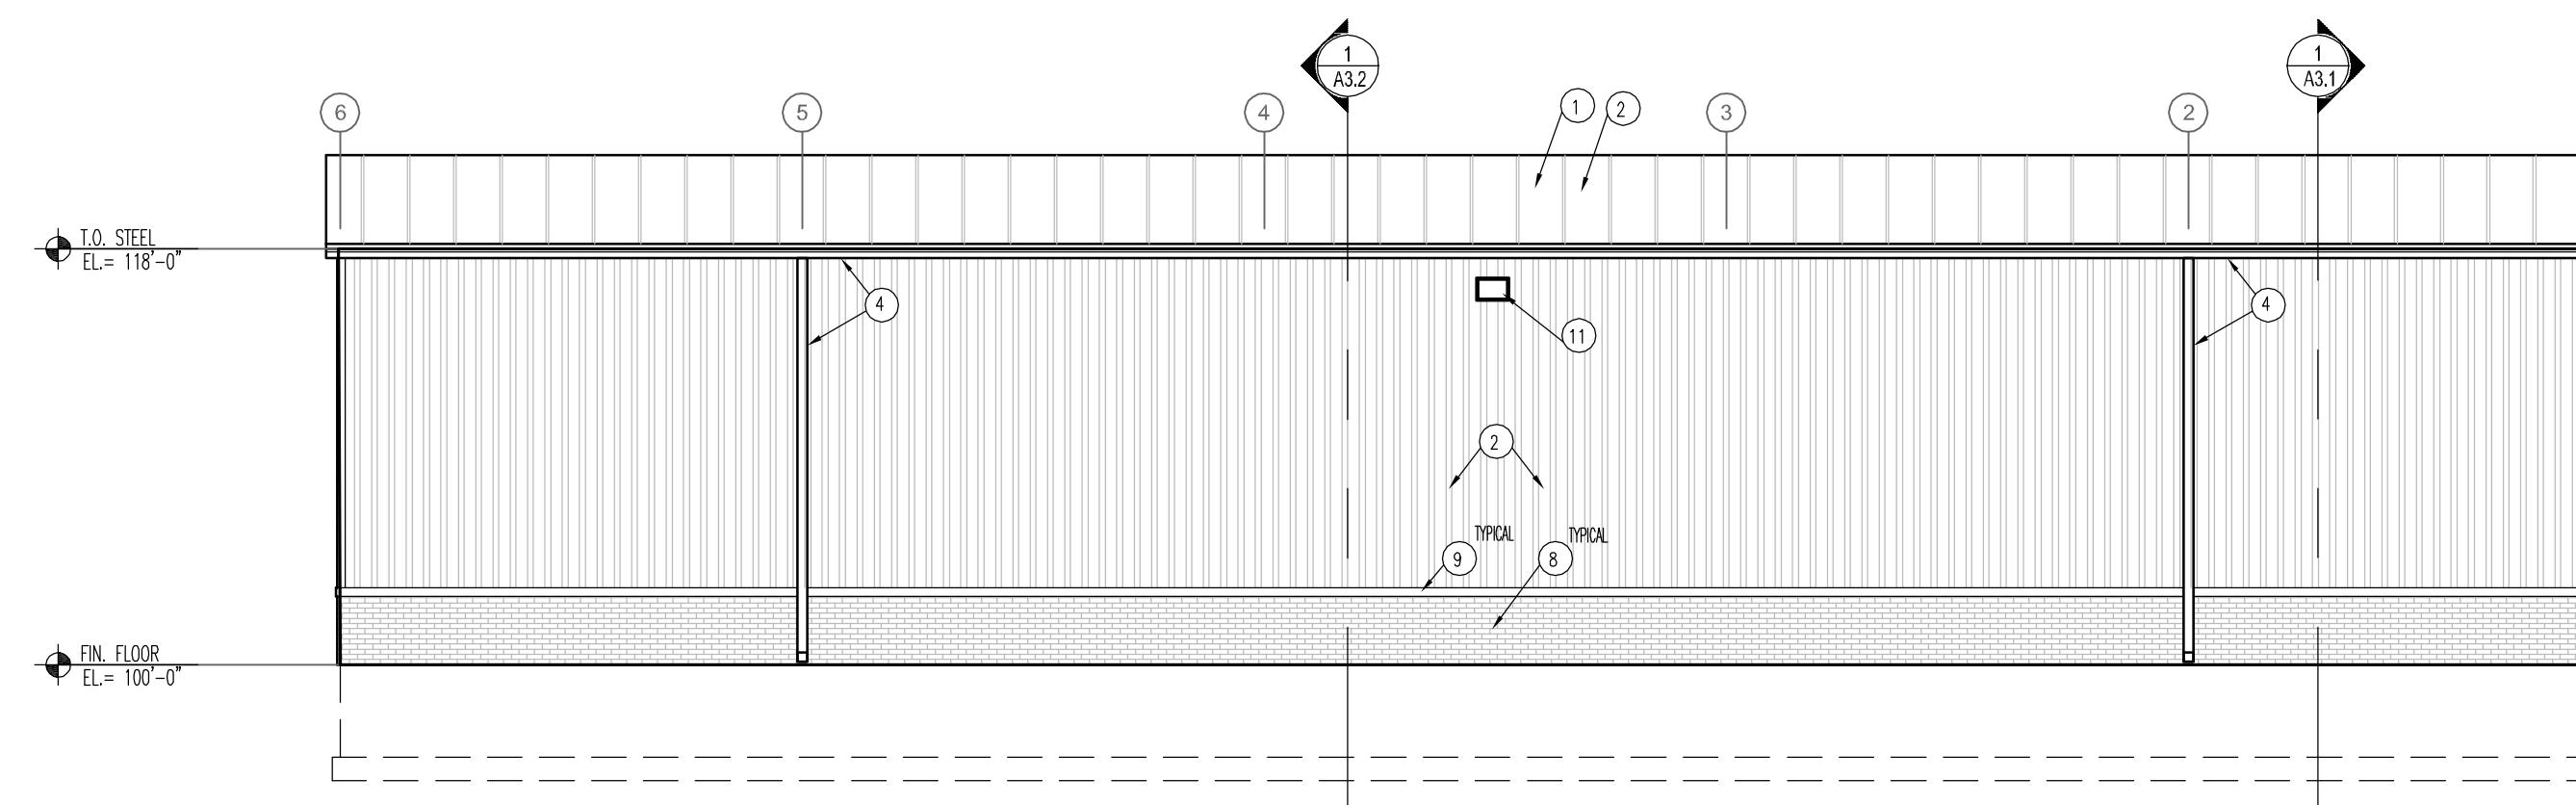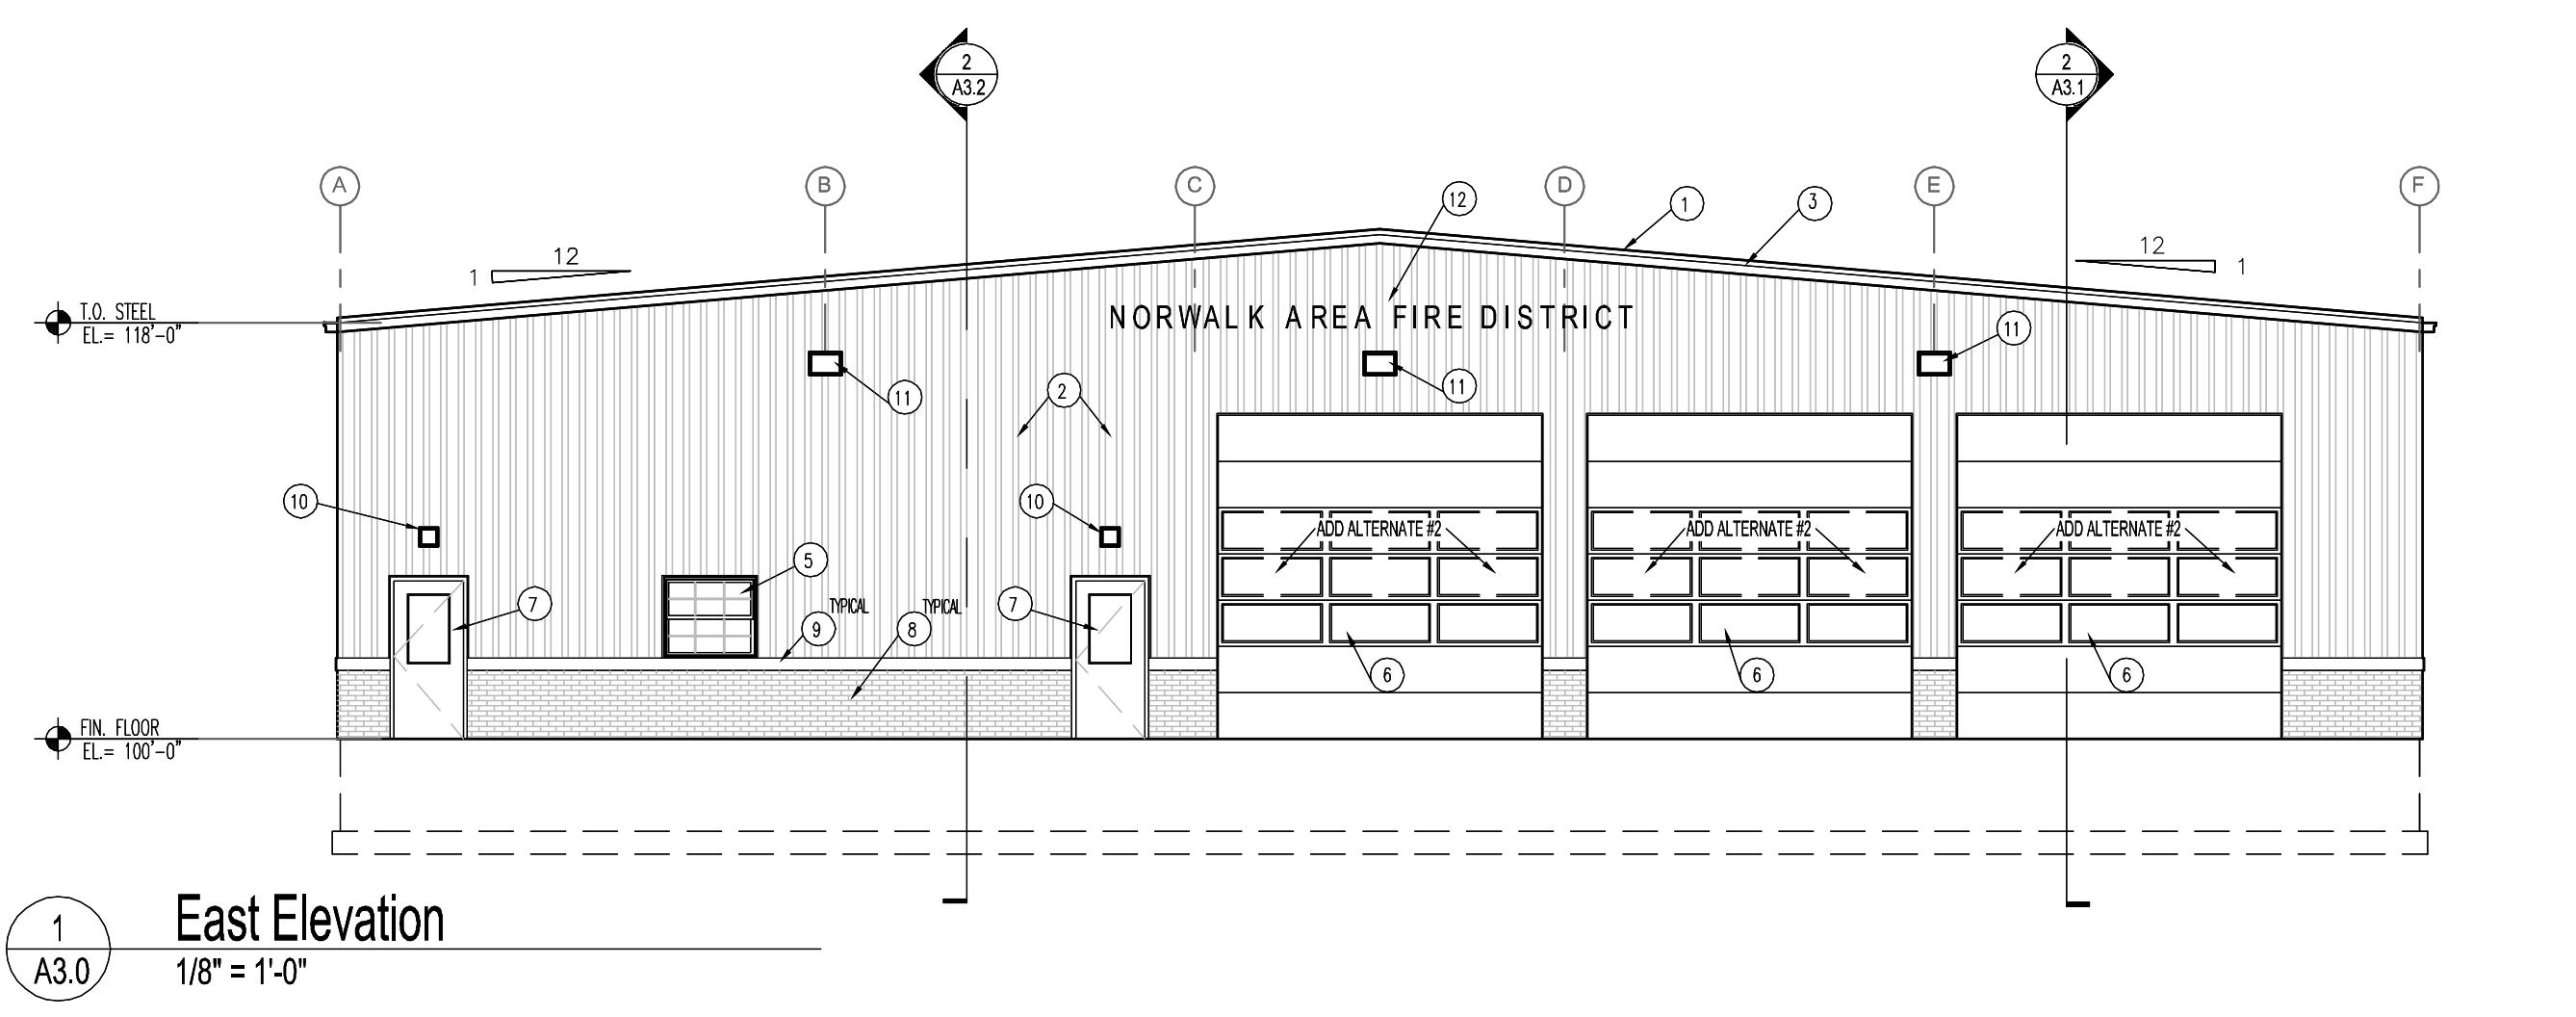

Keyed Notes- Exterior Elevations


- ① 24 GA. GVALUME FINISH STANDING SEAM METAL ROOFING
- ② 26 GA. KYNAR FINISH PAINTED METAL PANEL
- ③ PAINTED METAL FASIA
- ④ NEW PAINTED METAL GUTTER / DOWNSPOUT
- ⑤ NEW EXTERIOR WINDOWS, TYPICAL- SEE SCHEDULE- 5 A3.0
- ⑥ INSULATED OVERHEAD GARAGE DOORS WITH VISION PANELS- SEE SCHEDULE ADD ALTERNATE #2 ADD ADDITIONAL VISION PANELS AS SHOWN
- ⑦ STEEL FRAME INSULATED EXTERIOR DOOR - SEE SCHEDULE
- ⑧ 'SPEEDY'-MASON BRICK VENEER SYSTEM.
- ⑨ 'SPEEDY'-MASON STONE SILL VENEER SYSTEM.
- ⑩ EXTERIOR EXIT LIGHTING
- ⑪ ADJUSTABLE CUT-OFF WALL PACK EXTERIOR FLOOD LIGHTING

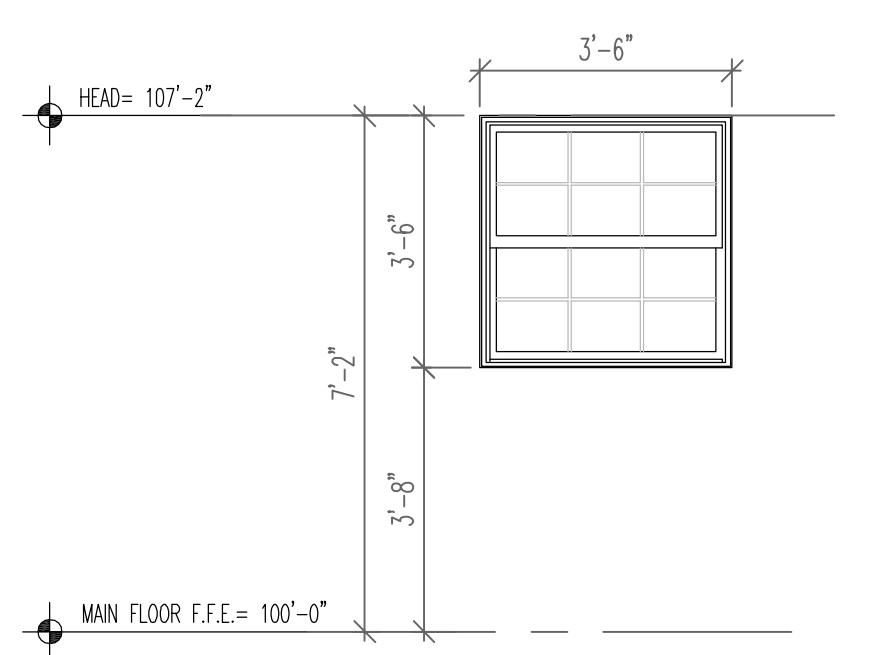

FIBERGLASS EXTERIOR WINDOWS
 MARVIN ESSENTIAL SERIES
 1", NOMINAL, INSULATED, DOUBLE-GLAZED
 LOW E', ARGON-GAS FILLED, CLEAR GLASS
 SHADING COEFFICIENT: 0.60 +/-
 SHGC = 0.38 +/-
 U= 0.30 MAXIMUM
 PROVIDE SAFETY GLASS WHERE REQUIRED

5 A3.0 3/8" = 1'-0"
 Exterior Window Schedule

A3.3 Wall Sections

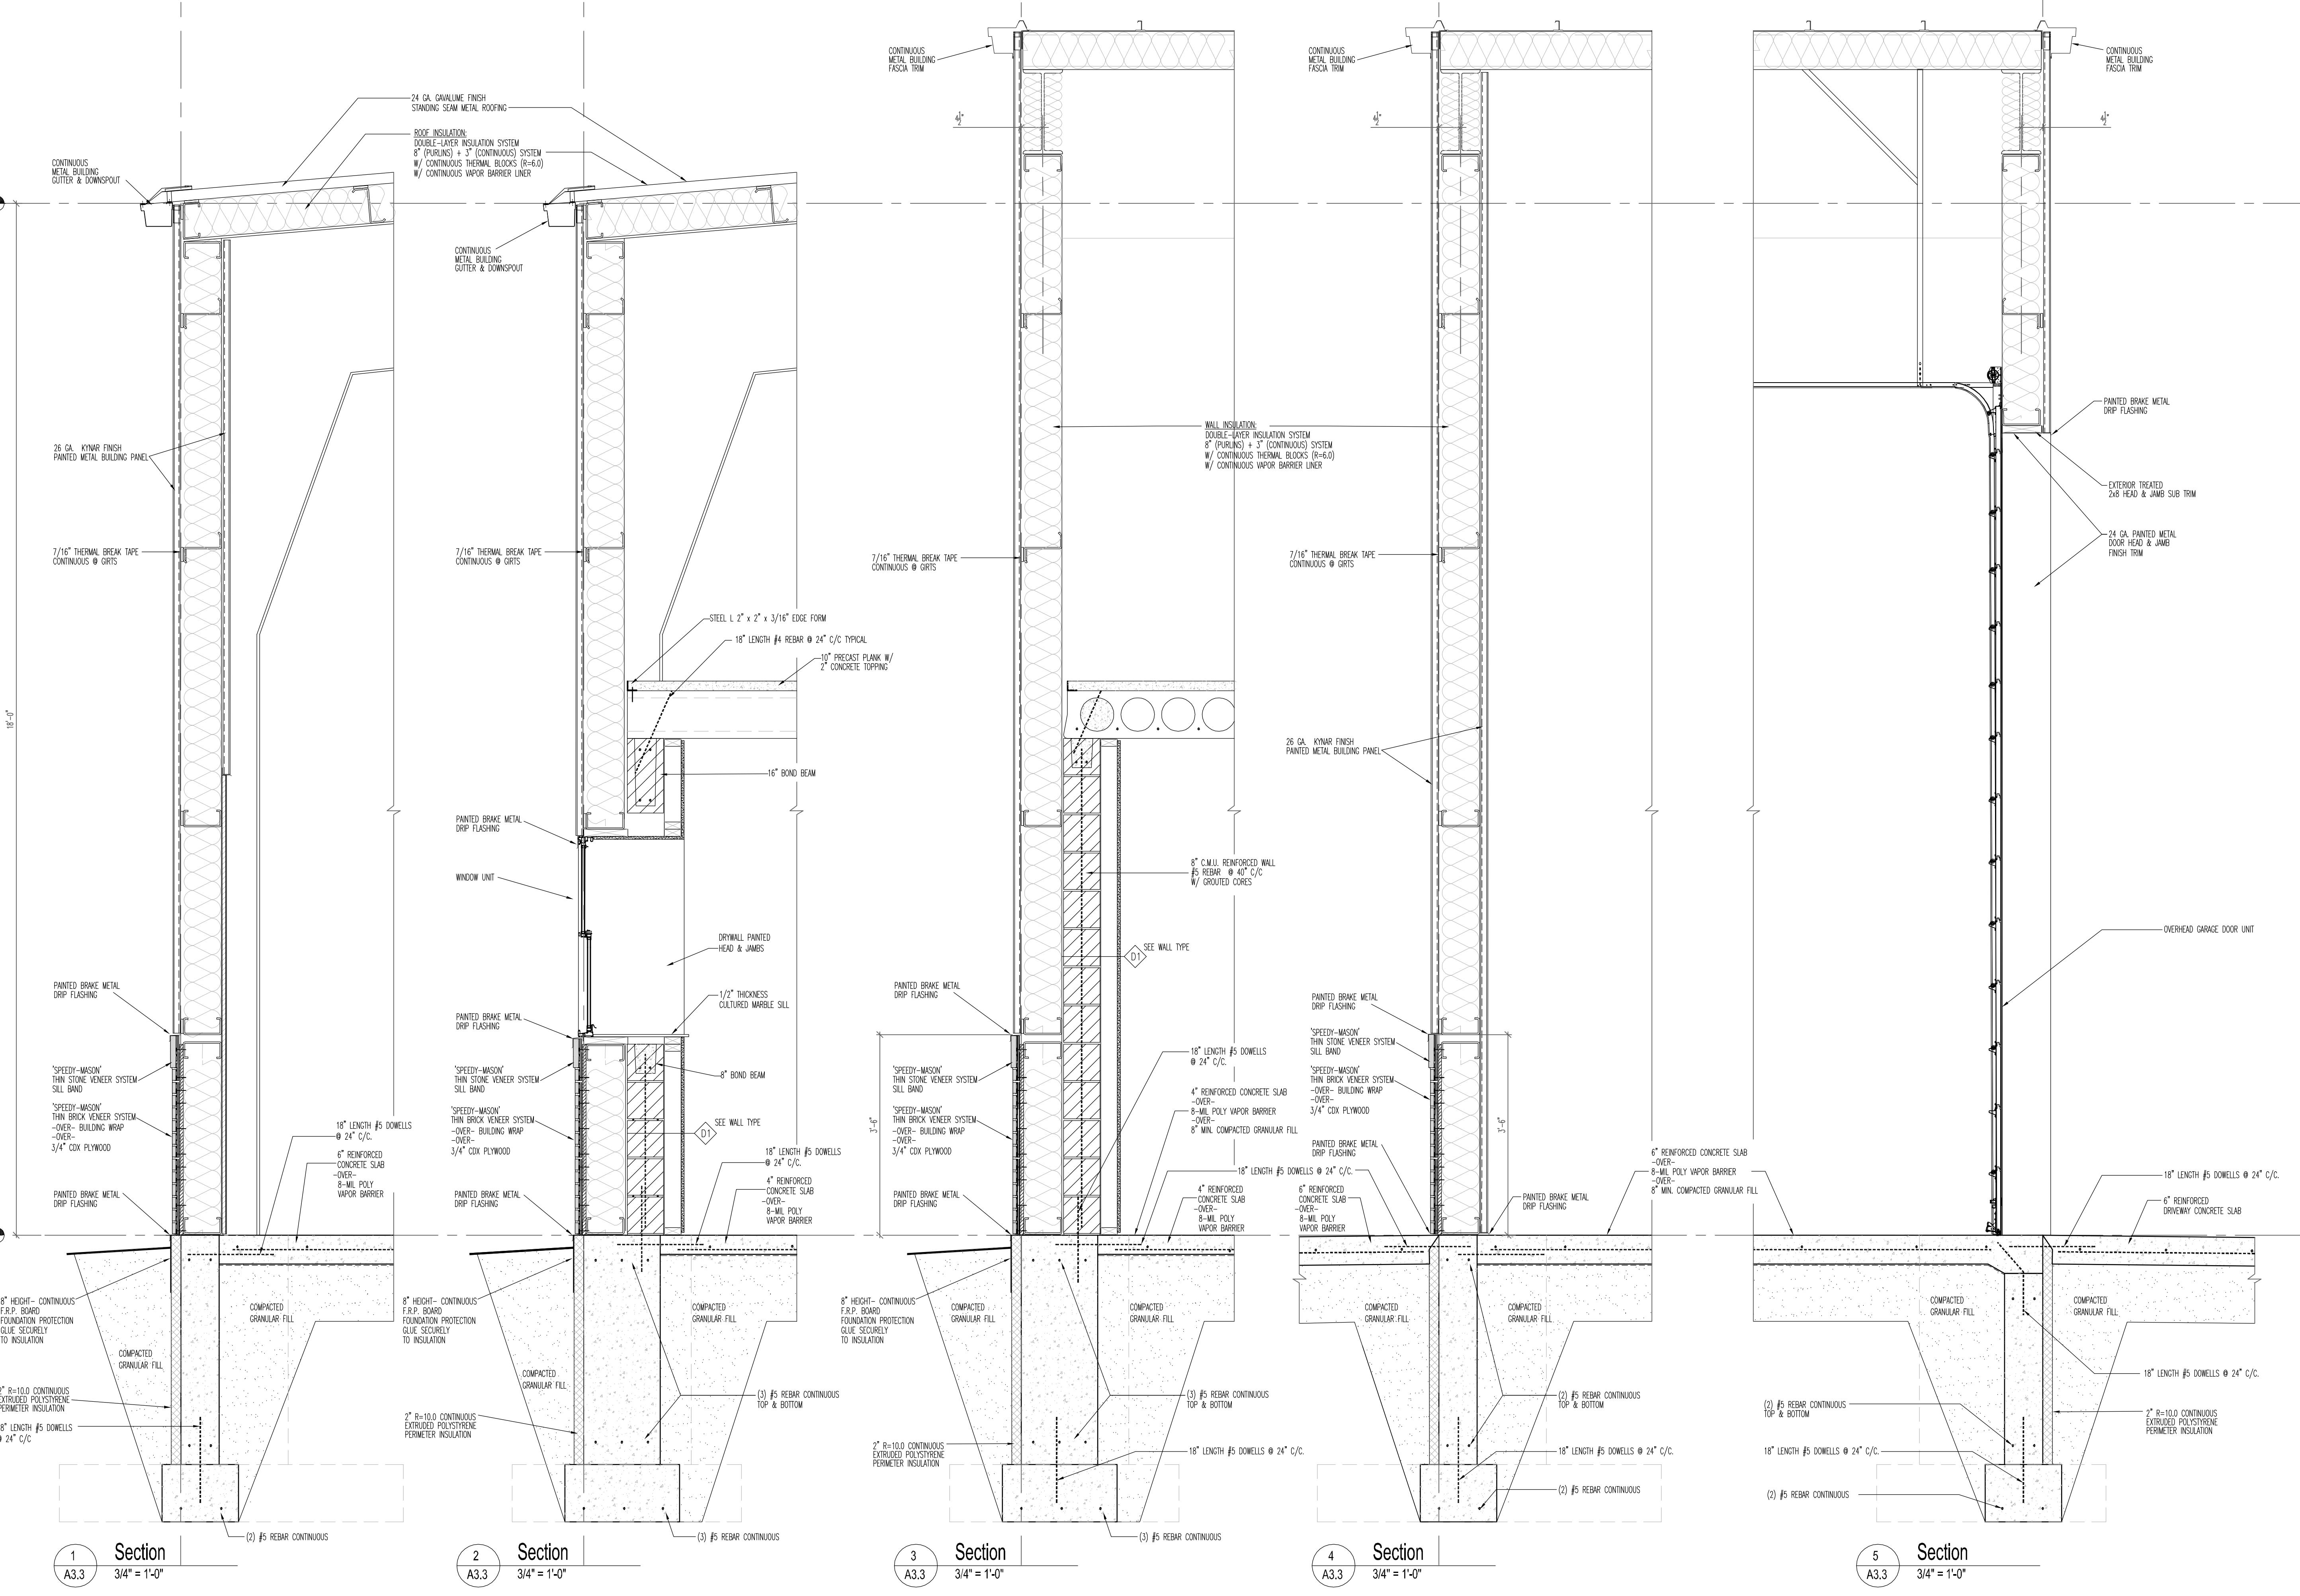

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REVISIONS
NO. DATE

PROJECT: Norwalk Area Fire District
LOCATION: 212 Main Street Norwalk, WI Monroe County

DATE: November 19, 2005

212 Main Street Norwalk, WI Monroe County

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